

TOWN OF GIBBONS MUNICIPAL PLANNING COMMISSION (MPC) AGENDA TO BE HELD AUGUST 12, 2025, AT 6:30 PM AT THE MUNICIPAL OFFICE

1.0	CALL TO ORDER					
2.0	ADOPTION OF THE AGENDA					
3.0	ADOP ⁻	TION OF THE MINUTES				
	3.1	Municipal Planning Com	mission Meeting Minutes July 15, 2025			
4.0	OLD B	USINESS				
5.0	NEW E	BUSINESS				
	5.1	Permit Number: Proposed Development: Subject Site:	25-D0038 Single Family Dwelling Lot 25, Block 31, Plan 192 2297 27 Maple Crescent, Gibbons, AB			
		Zoning:	R-1C Single Family Small Lot Residentia			
	5.2	Permit Number: Proposed Development: Subject Site:	25-D0039 Roof Top Solar System Lot 29, Block 25, Plan 782 1890 4823 44 Avenue, Gibbons, AB			
		Zoning:	R-1 Singel Family Residential			
6.0	NEXT	MPC MEETING – August	27, 2025 (tentatively)			

7.0 ADJOURNMENT

MINUTES OF THE MUNICIPAL PLANNING COMMISSION OF THE TOWN OF GIBBONS HELD ON WEDNESDAY, JULY 15, 2025, AT 4807 – 50th AVENUE IN COUNCIL CHAMBERS

Municipal Planning Commission:

Chair Yushchyshyn

Member Willis Kozak Member Jay Millante

Members Absent

Staff Present:

Terra Pattison – Finance Manager

Chris Pinault - Secretary

2.0 ADOPTION OF THE AGENDA

Member Kozak moved to accept the agenda as presented.

MPC 25.010 MOTION CARRIED

3.0 ADOPTION OF THE MINUTES

3.1 MINUTES OF THE MUNICIPAL PLANNING COMMISSION – JUNE 25, 2025

Member Kozak moved to adopt the Minutes of the MPC Meeting held on June 25, 2025.

MPC 25.011 MOTION CARRIED

4.0 OLD BUSINESS

5.0 DEVELOPMENT PERMIT APPLICATIONS

5.1 PERMIT #25-D0037

LEGAL DESCRIPTION	Block OT, Plan 912 0230		
CIVIC ADDRESS	23230 Twp Rd 561A, Gibbons, AB		
LAND USE DISTRICT	Highway Commercial (C-3) District		
PROPOSED	Erect A Temporary 150' X 150' X 23' Double Truss Tent		
DEVELOPMENT			

Member Kozak moved that the Municipal Planning Commission approve the temporary erection of a 150' X 150' X 23' Double Truss Tent with a permit expiry date of December 31, 2034, to be located at Block OT; Plan 912 0230, 23230 Twp Rd 561A, Gibbons, AB, with the following conditions:

- 1. This is a temporary development permit with an expiry date of December 31, 2034. There shall be no servicing or permanent structures constructed on the site.
- 2. All development must be in accordance with the approved site plan
- 3. All loading and off-loading shall be done within the property.
- 4. Any future development will require a new permit application.
- 5. A person applying for, or in possession of a valid Development Permit is not relieved from full responsibility for ascertaining and complying with or carrying out development in accordance with the conditions of any covenant, caveat, easements, or other instrument affecting the building or the land. All development must comply with all regulations and requirements of the Town of Gibbons Land Use Bylaw, the Alberta Safety Codes Act, and all other relevant legislation.

Please note an approval of the Municipal Planning Commission is subject to an appeal period that ends on <u>AUGUST 5, 2025.</u>

MPC 25.012 MOTION CARRIED

6.0 NEXT MUNICIPAL PLANNING COMMISSION MEETING

Member Millante moved to set the date of the next meeting as August 12, 2025, if required.

MPC 25.013 MOTION CARRIED

7.0 ADJOURNMENT

There being no further business Chair Yushchyshyn adjourned the meeting at 6:35 pm.

Chair Yushchyshyn	Interim CAO Eric Lowe

MUNICIPAL PLANNING COMMISSION (MPC) REQUEST FOR DECISION

Proposed Development: Single Family Dwelling

Subject Site:

Lot 25, Block 31, Plan 192 2297 - 27 Maple Crescent, Gibbons, AB

Zoning:

R-1C Single Family Small Lot Residential

Permit Number:

25-D0038

Application Information

An application for the construction of a single family dwelling was received by the planning department and deemed complete on July 30, 2025. The proposed development is a permitted use in the R-1C Single Family District and requires a variance of 12.5% to the maximum site coverage and as such has come to MPC for a decision.

Section 4.4 of the Land Use Bylaw 8-06 provides that the maximum site coverage be 35%. The proposed application proposes a site coverage of 40%. All other development regulations in the districts are met.

Recommendation

That the Municipal Planning Commission approve the application for the construction of a Single Family Dwelling with a lot coverage of 40% to be located at Lot 25; Block 31; Plan 192297 – 27 Maple Crescent, Gibbons, AB with the following conditions:

- 1. Development shall proceed in accordance with the attached plans.
- 2. Prior to occupancy of the development, the Registered Owner/Applicant shall obtain a post-construction Lot Grading Certificate, prepared by a registered Alberta Land Surveyor, and provide the Certificate to the Development Officer. The Lot Grading Certificate must demonstrate that the post-construction lot grades, drainage, and elevations are consistent with the approved Lot Grading and Drainage Plan, included in the attached plans.
- 3. The development shall utilize the existing municipal services for the lot. Should any new or expanded municipal services be required to service the development, the applicant will be required to enter into and abide by a Development Agreement with the Town of Gibbons, provide security, and install services, at the Developer's sole expense, in accordance with the Town of Gibbons Municipal Servicing Standards for Development.
- 4. The Developer shall arrange for the inspection, by the Town Operations Department, of the water and sewer line hookups prior to backfilling. The Town shall install the water meter and turn on the water once heat has been provided to the development if required (no risk of freezing). The Developer is not authorized to access the curb stop.
- 5. The Developer is responsible for ensuring that pre-construction and post construction site inspections are completed by Town Operations Department and that any concrete, lane ways or other municipal works damaged during construction by vehicles and equipment are restored to the original state at the Developer's sole expense, to the satisfaction of the Town Operations Department.
- 6. If the development authorized on this development permit is not commenced within twelve (12) months of the Date of Issuance, or the applicant has not obtained an approved Building Permit within twelve (12) months from the Date of Issuance, the Development Permit shall be deemed void.


7. The Applicant/Registered Owner shall ensure there is no damage to municipal property resulting from this permit. Costs for repairs of municipal property will be assessed by the Town of Gibbons and will be charged back to the applicant.


NOTES:


- 1. If the development is found to be incorrectly placed, the applicant may be required to move or remove the development at the sole expense of the Applicant/Registered Owner. Any proposed change considered to be substantial or inconsistent with this approval, as determined by the Development Officer, may be subject to a separate development permit application/approval.
- 2. An appeal can be made by filing a written notice of appeal along with payment to the Subdivision and Development Appeal Board (4807 50 Avenue, Box 68, Gibbons, AB, T0A 1N0) within 21 days from the date of the receipt of this decision. In the case of an appeal made by a person referred to in section 685(2) of the Municipal Government Act, within 21 days after the date on which the notice of the issuance of the permit was given.
- 3. This is a Development Permit ONLY. Issuance of this Permit does not excuse the applicant from satisfying all other applicable municipal, provincial and/or federal requirements.
- 4. A person applying for, or in possession of a valid Development Permit is not relieved from full responsibility for ascertaining and complying with or carrying out development in accordance with the conditions of any covenant, caveat, easements, or other instrument effecting the building or the land.


Submitted By:

Terra Pattison,
Acting Development Officer

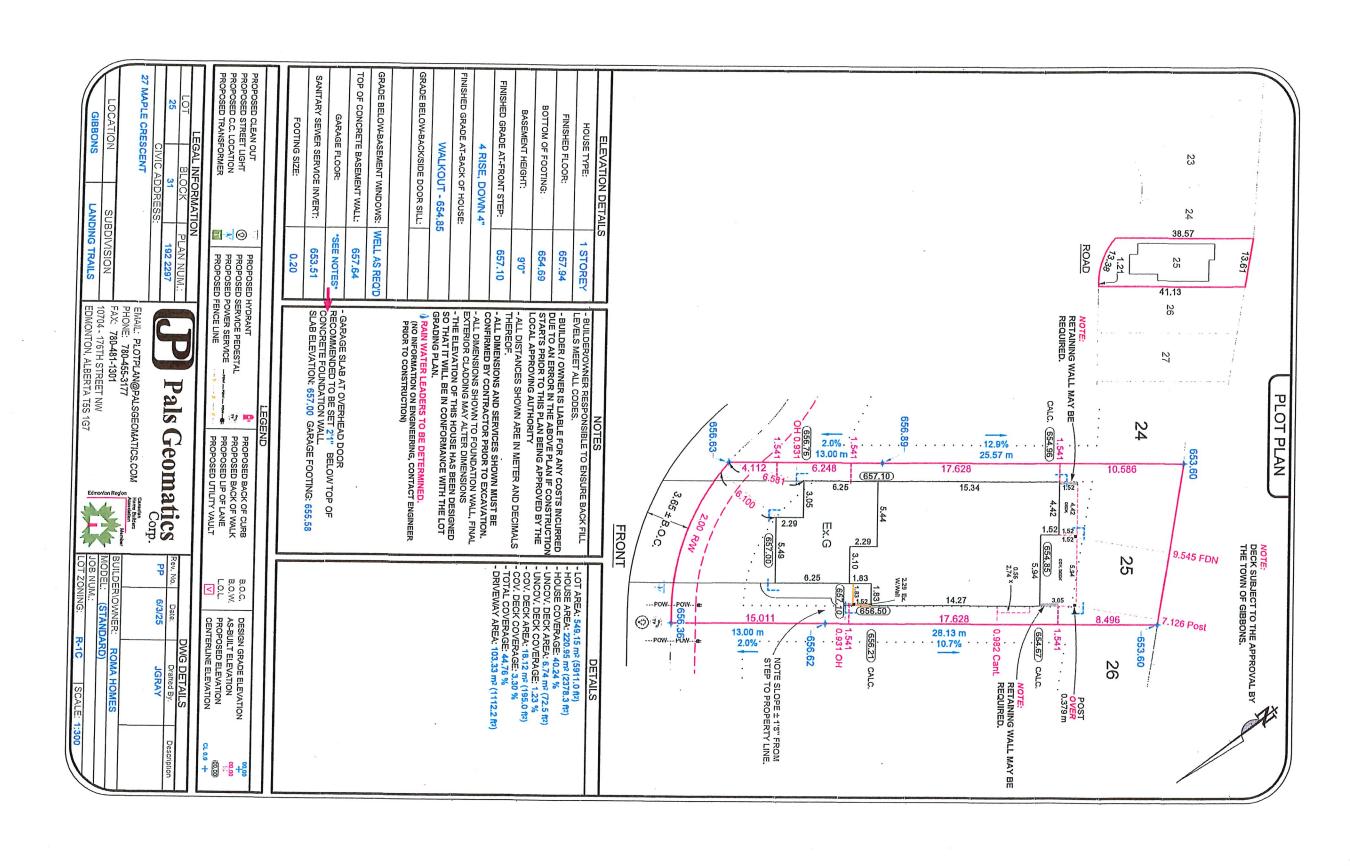

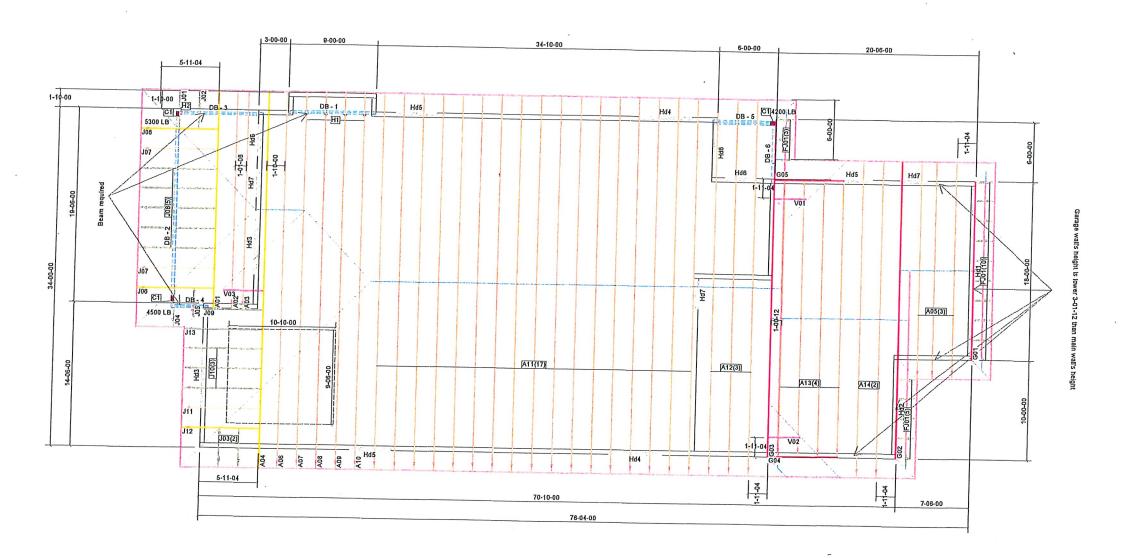

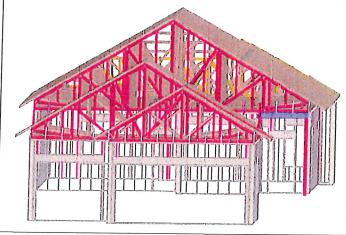

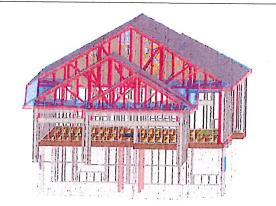

This model is available to view in 3D for free with the MiTek Viewer app for Phone, Tablet or Desktop. Ask us how at winterburn@nlc.ca

		Products		
PlottD	Length	Product	Plies	Net Qty
DB - 1	10-00-00	1-3/4" x 9-1/2" VERSA-LAM® LVL 2.1E 2800 DF	2	2
DB - 2	20-00-00	1-3/4" x 11-7/8" VERSA-LAMD LVL 2.1E 2800 DF	2	2
DB - 3	10-00-00	2x8 SPF No.2	2	2
DB - 4	4-00-00	2x8 SPF No.2	2	2
DB - 5	7-00-00	2x10 SPF No.2	3	3
DB - 6	6-00-00	2x10 SPF No.2	3	3
C1	9-08-10	2x6 SPF No.2	3	9

	Wall Framing		
Length	Product	Plies	Net Qty
18-00-00	1-3/4" x 9-1/2" VERSA-LAM® LVL 2.1E 2800 DF	2	2
10-00-00	2x10 SPF No.2	2	2
7-00-00	2x10 SPF No.2	2	4
6-00-00	2x10 SPF No.2		4
5-00-00	2x10 SPF No.2	2	6
4-00-00	2x10 SPF No.2		6
3-00-00	2x10 SPF No.2	2	6
	18-00-00 10-00-00 7-00-00 6-00-00 5-00-00 4-00-00	Length Product 18-00-00 1-3/4" x 9-1/2" VERSA-LAM® LVL 2.1E 2800 DF 10-00-00 2x10 SPF No.2 6-00-00 2x10 SPF No.2 5-00-00 2x10 SPF No.2 4-00-00 2x10 SPF No.2 4-00-00 2x10 SPF No.2	Length Product Piles 18-00-00 1-3/4" x 9-1/2" VERSA-LAM® LVL 2.1E 2800 DF 2 10-00-00 2x10 SPF No.2 2 7-00-00 2x10 SPF No.2 2 6-00-00 2x10 SPF No.2 2 5-00-00 2x10 SPF No.2 2 4-00-00 2x10 SPF No.2 2 4-00-00 2x10 SPF No.2 2

PlotID Qly Manuf Product
H2 1 MITek THDH48

Ref Number:

251066

Customer Name: Roma Homes

Job Name:

Lot 25-31 Landing Trails

Location:

27 Maple Cres, Gibbons, AB

LOT: 25, BLK: 31, PLAN: 192-2297

Sales Person:

Drew Zinnick

Туре		Residential	
Ss:		37.6 lb/ft ³	
Sr:		2.1 lb/ft ³	
TC Live		- lb/ft2	R
TC Dead		- lb/ft2	K
BC Live		- lb/ft2	н
BC Dead		- lb/ft2	п
Total Load		- lb/ft2	Va
Date:		7/7/2025	
	Revision Dates		RI
	1		Ra
		-	Н

Roof Data oof Area 3621.87 ft *Sqft p Lines dge Lines ke Lines orizontal OH Line 243.78linear N

This is a placement plan only. Any discrepancies between this placement plan and the architectural drawings should be reported back to Nelson Lumbprior to construction. <u>PO NOT CUT TRUSSES</u> unless proper repair details have been supplied. Please refer to the Nelson Lumber Installation Guide. Please refer to the Nelson Lumber Installation Guide.


91.7linear ft All truss spacings are 24" oc unless otherwise noted. Layouts & Engineered Drawings have been created using MiTek software version 8.5.1.199. See engineered truss drawings for spacing, piles, bracing, and neilling pattern.


106.97linear ft engineered drawings for truss information


DO NOT SCALE DRAWING





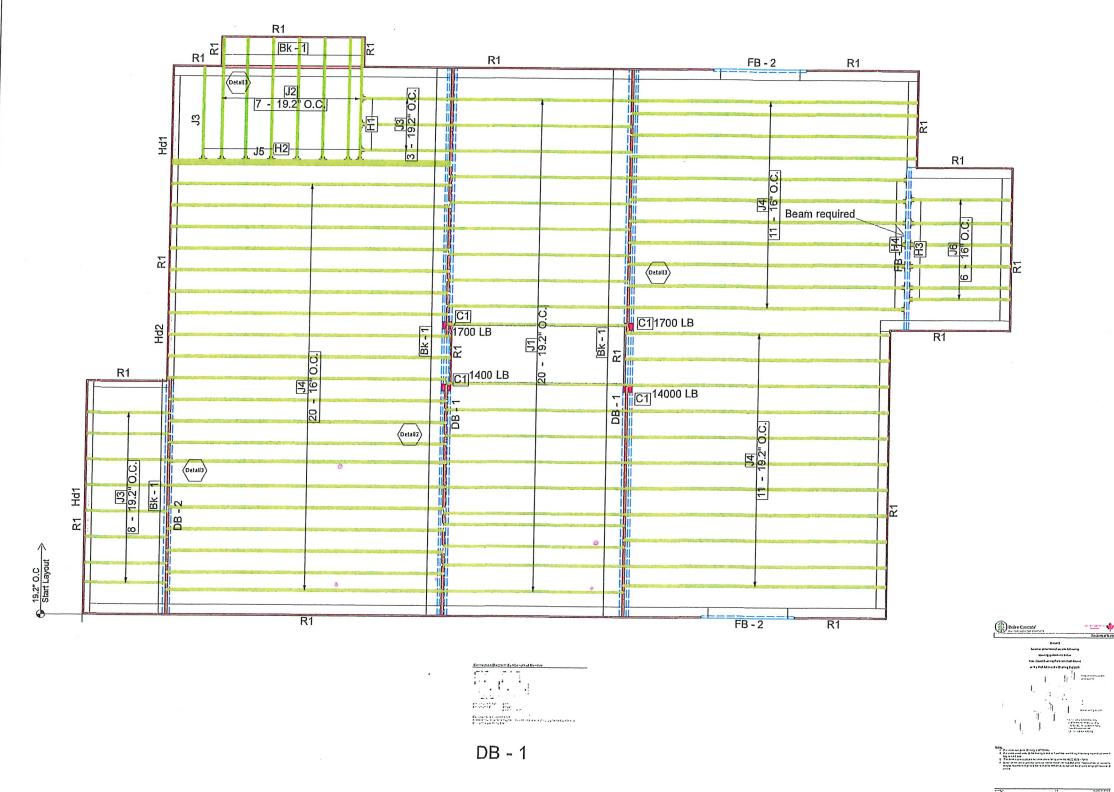

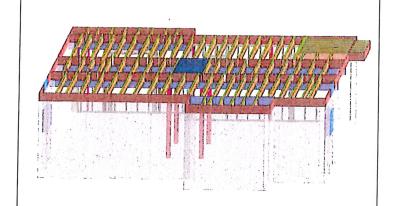

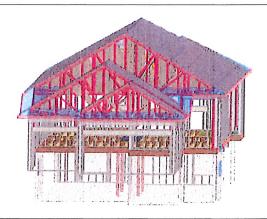

This model is available to view in 3D for free with the MiTek Viewer app for Phone, Tablet or Desktop. Ask us how at winterburn@nlc.ca

		Products		
PlotID	Length	Product	Plies	Net Qty
J1	12-00-00	11-7/8" BCI® 5000-1.7 DF	1	20
J2	8-00-00	11-7/8" BCI® 5000-1.7 DF	1	7
J3	6-00-00	11-7/8" BCI® 5000-1.7 DF	1	12
J4	18-00-00	11-7/8" BCI® 6000-1.8 DF	1	42
J5	18-00-00	11-7/8" BCI® 6000-1.8 DF	2	2
J6	8-00-00	11-7/8" BCI® 6000-1.8 DF	1	6
DB - 1	34-00-00	1-3/4" x 9-1/2" VERSA-LAM® LVL 2,1E 2800 DF	4	8
DB - 2	16-00-00	1-3/4" x 9-1/2" VERSA-LAM® LVL 2.1E 2800 DF	3	3
FB - 1	12-00-00	1-3/4" x 11-7/8" VERSA-LAM® LVL 2.1E 2800 DF	2	2
FB - 2	6-00-00	1-3/4" x 11-7/8" VERSA-LAM® LVL 2,1E 2800 DF	1	2
R1	12-00-00	1-1/8X11-7/8 OSB Plus	1	16
Bk - 1	2-00-00	.11-7/8" BCI® 5000-1.7 DF	1	80
C1	8-02-08	RJ25X108 (18400bs) CW "C" 5.25"X7"	1	4

			all Framing		
PlotID	Leng	lh Pro	duct	Plies	Net Qty
Hd1	6-00-	00 2x1	0 SPF No.2	2	4
Hd2	3-00-	00 2x1	0 SPF No.2	2	2
	Connec	ctor Sumi	пагу	-	
PlotID	Qly	Manuf	Product	-	
114	2	AUT-L.	TEL 00440	-	

H2 H3 H4 MiTek TFL20118 MiTek TFL20118 MiTek TFL23118

Main Floor Layout

This is a placement plan only and is to be used in conjunction with the architectural drawings. Refer to Bolse Handling & Installation Recommendations for proper Installation procedures. Locate all plumbing and mechanical drops prior to installation. Any discrepancies between the layout and plans are to be reported back to Nelson Lumber prior to construction. Web stiffeners are required if the top flange of i-joist is not supported by the hanger. Provide min 2x6 blocking at all locations where point loads are required to transfer loads through the floor joist system. Absolutely no joists, beams or floor trusses are to be modified without contacting Nelson Lumber first. Loads noted are factored unless noted otherwise. Layouts & Engineered Drawings have been created using MITek software version 8.8.3.256. See drawings for spacing, piles, bracing, and nailing/screw patterns. All loads are factored loads





Туре Residential TC Live 40.0 lb/ft3 TC Dead 10.4 lb/ft³ BC Dead 5.2 lb/ft² Total Load Date: 7/7/2025

Revision Dates

Floor Loadings

LOT: 25, BLK: 31, PLAN: 192-2297

Lot 25-31 Landing Trails

27 Maple Cres, Gibbons, AB

Sales Person:

Ref Number:

Job Name:


Location:

Drew Zinnick

251066

Customer Name: Roma Homes

DO NOT SCALE DRAWING

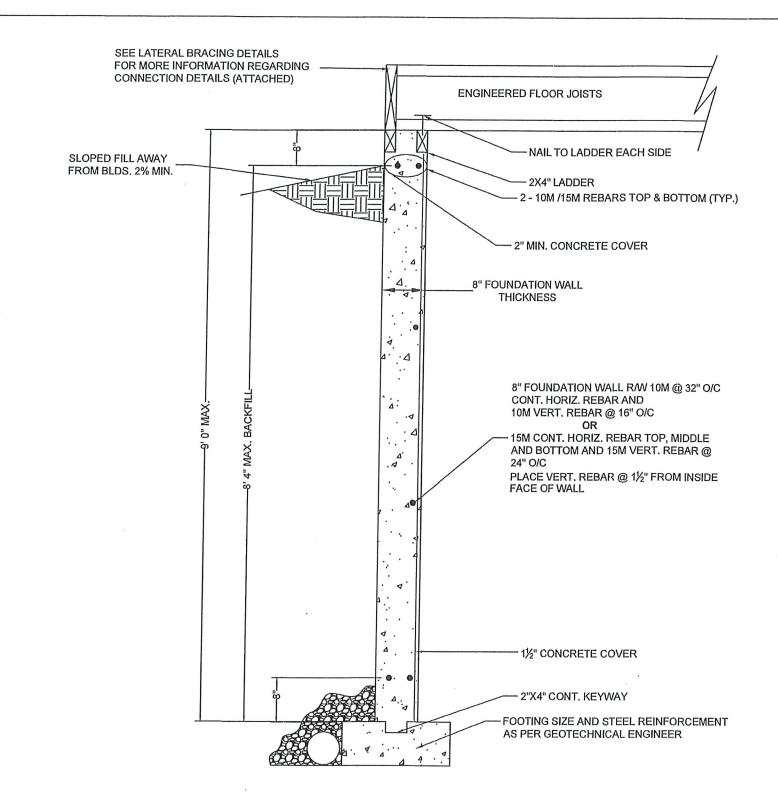

1. ALL OF THE CONSTRUCTION SHALL BE IN ACCORDANCE WITH THE NATIONAL BUILDING CODE 2023 (AE). SEE MANUFACTURER INSTRUCTIONS FOR INSTALLATION/SUPPORT OF ENGINEERED FLOOR JOISTS.

3. CONCRETE

- 32 MPA TYPE 50 (HS) OR SPECIFIED IN SULPHATE TEST REPORT
 ALL CONCRETE EXPOSED TO FREEZE/THAW CYCLE HAS A MINIMUM AIR ENTRAINMENT OF 5-7%
- INTERNAL VIBRATION WITH A 31.8mm (1.25") MECHANICAL VIBRATOR
- MAXIMUM CONCRETE FORM PRESSURE (HURD, THUNMAN) 29kPa

4. REINFORCING STEEL

- IT IS DESIGNED TO CSA A23.3-94
- IT REINFORCES TO CSA CAN-A23.1-M90 AND CSA G30.12.M77
- ITS STRENGTH 400 Mpa
- 5. PROVIDE WEEPING TILES AROUND FOOTINGS C/W DRAIN GRAVEL
- 6, FOOTING SIZES AS PER CURRENT ABC AND/OR GEOTECHNICAL ENGINEER'S RECOMENDATIONS

THE CONTRACTOR TO VERIFY ALL DIMENSIONS AND DATA NOTED ON THE STRUCTURAL DRAWING WITH CONDITIONS ON SITE, CO-ORDINATE ALL OF THE DIMENSIONS WITH THE ARCHITECTURAL DRAWINGS AND IS HELD RESPONSIBLE FOR REPORTING ANY DISCREPANCIES TO THE ENGINEER BEFORE PROCEEDING WITH THE WORK, VARIATIONS AND MODIFICATIONS TO WORK SHOWN ON THE STRUCTURAL DRAWINGS SHALL NOT BE CARRIED OUT WITHOUT WRITTEN PERMISSION FROM THE ENGINEER. THIS DRAWING NOT TO BE SCALED

ProtechGeo

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PERMIT TO PRACTICE PROTECHGEO & MATERIAL, TESTING LTD.

RM SIGNATURE:

RM APEGA ID #: ___131831

June 30, 2025

PERMIT NUMBER: P014414 The Association of Professional Engineers and Geoscientists of Alberta (APEGA)

THE CONTRACTOR SHALL CHECK AND VERIFY ALL DIMENSIONS AND OTHER CONDITIONS ON SITE.

WRITTEN DIMENSIONS SHALL HAVE PRECEDENCE OVER SCALED DIMENSIONS

DRAWINGS ARE PROPERTY OF PROTECHGEO & MATERIAL TESTING LTD.

Drawing Title: 9' 0" FOUNDATION WALL DESIGN


Client: ROMA HOMES PTG Project No.: 012825E03 Address: 27 MAPLE CRESCENT, LANDING TRAILS, GIBBONS, AB.

Legal: LOT 25, BLOCK 31, PLAN 192 2297

Date: June 30, 2025

Scale: N.T.S Drawn By: H.SIDHU Drawing No.: HW Rev No.: 0


STATUS.: PERMIT APPLICATION

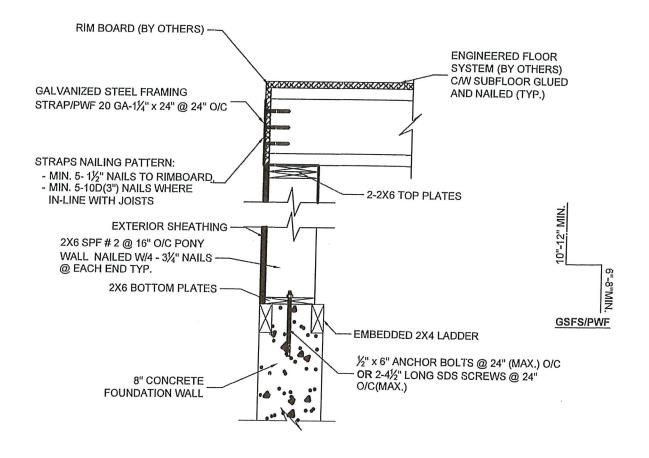

DETAIL: JOISTS PERPENDICULAR TO WALLS

NOTE:

- PONY WALL CONNECTION TO FOUNDATION WALL: SILL PLATE INSTALLED OVER SILL GASKET & AIR FLOW RETARDER 2X6 BOTTOM PLATE
- ELASTOMERE WATERPROOF MEMBRANE REQUIRED ON OUTSIDE WALL IF BACKFILL HEIGHT WITHIN 6" BELOW LADDER

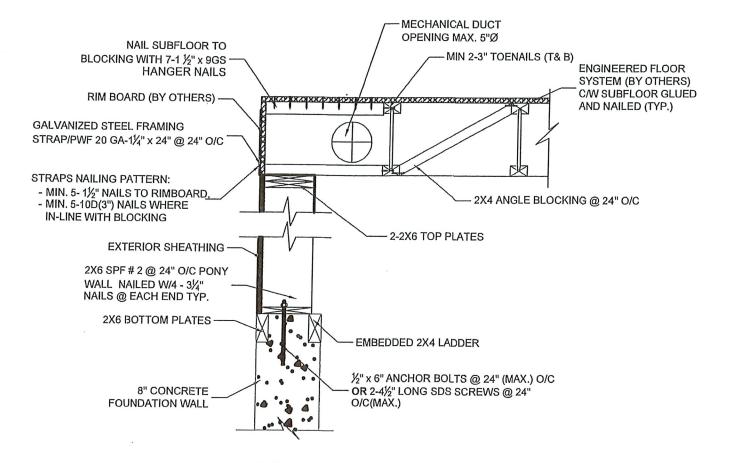

- PONY WALL CONNECTION TO FOUNDATION WALL: SILL PLATE INSTALLED OVER SILL GASKET & AIR FLOW RETARDER 2X6 BOTTOM PLATE
- ELASTOMERE WATERPROOF MEMBRANE REQUIRED ON OUTSIDE WALL IF BACKFILL HEIGHT WITHIN 6" BELOW LADDER

DETAIL: JOISTS PARALLEL TO WALLS

- 1. ALL OF THE CONSTRUCTION SHALL BE IN ACCORDANCE WITH NATIONAL BUILDING CODE 2023 (AE)
- MINIMUM CONCRETE COMPRESSIVE STRENGTH 32MPA @ 56 DAYS
- 3. LATERAL LOAD SOIL PRESSURE MAX. 50psf OF DEPTH
- ALL OF THE NAILS, SPIKES AND STAPLES TO BE IN CONFORMANCE WITH CSA B 111, FOR THE EXTERIOR LOCATIONS USE GALVANISED CONNECTORS AND PWF LUMBER THE FOUNDATION CONTRACTOR SHALL NOTIFY ENGINEER OF ANY DISCREPANCY OR DEVIATION IN EXISTING CONDITION, PRIOR TO WORK PROCEEDING.
- ALL CANTILEVER AREA PROVIDE 2x6 NAILED AND GLUED TO EACH PERPENDICULAR JOIST PARALLEL TO WALL.
- INSPECTION BY PROTECHGEO FOR CONFORMANCE TO ABOVE INSTALLATION REQUIREMENTS WILL NOT BE DONE UNLESS SPECIFICALLY REQUESTED BY CLIENT/OWNER.



6036 - Gateway Blvd, Edmonton, AB. T6H 2H6 E-mail: rsgill@protechgeo.com; Phone: 780-265-3790



PERMIT TO PRACTICE PROTECHGEO & MATERIAL, TESTING LTD. RM APEGA ID #: __1318311 June 30, 2025

PERMIT NUMBER: P014414 The Association of Professional Engineers and Geoscientists of Alberta (APEGA)

THE CONTRACTOR SHALL CHECK AND VERIFY ALL
DIMENSIONS AND OTHER DATA NOTED HEREIN WIT CONDITIONS ON SITE.

WRITTEN DIMENSIONS SHALL HAVE PRECEDENCE OVER SCALED DIMENSIONS

RAWNGS ARE PROPERT OF PROTECHGEO & MATERIAL TESTING LTD.

Drawing Title: PONY WALL LATERAL BRACING

Client: ROMA HOMES PTG Project No.: 012825E03

Address: 27 MAPLE CRESCENT. LANDING TRAILS, GIBBONS, AB.


Legal: LOT 25, BLOCK 31, PLAN 192 2297

Date: June 30, 2025

Drawn By: H.SIDHU Scale: N.T.S

Drawing No.: LBP Rev No.: 0


STATUS.: PERMIT APPLICATION

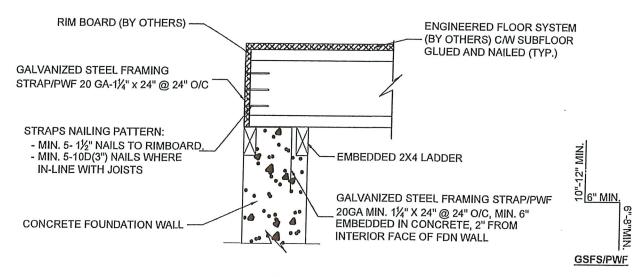

DETAIL: JOISTS PERPENDICULAR TO WALLS

ANY OF THE OPENINGS.

- ELASTOMERE WATERPROOF MEMBRANE REQUIRED ON OUTSIDE
- WALL IF BACKFILL HEIGHT GREATER THAN 6" BELOW LADDER STRAPS REQUIRED ONLY FOR WALLS OVER 15' LENGTH AND AT

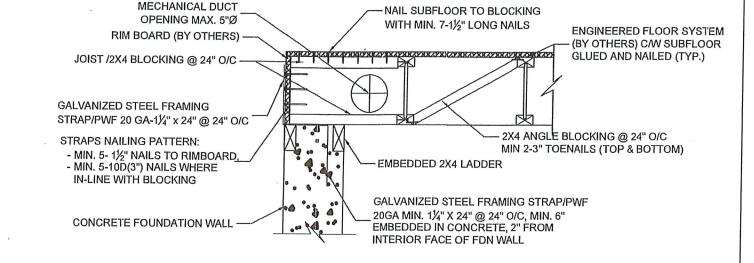

DETAIL: JOISTS PARALLEL TO WALLS

NOTE:

- ELASTOMERE WATERPROOF MEMBRANE REQUIRED ON OUTSIDE WALL IF BACKFILL HEIGHT GREATER THAN 6" BELOW LADDER
- STRAPS REQUIRED ONLY FOR WALLS OVER 15' LENGTH AND AT ANY OF THE OPENING

LATERAL BRACING DETAIL FOR: 9' 0" MAX. FOUNDATION WALLS WITH 8' 4" MAX. BACKFILL

- 1. ALL OF THE CONSTRUCTION SHALL BE IN ACCORDANCE WITH NATIONAL BUILDING CODE 2023 (AE)
- MINIMUM CONCRETE COMPRESSIVE STRENGTH 20MPa @ 28 DAYS
- LATERAL LOAD SOIL PRESSURE MAX. 50psf OF DEPTH
- ALL OF THE NAILS, SPIKES AND STAPLES TO BE IN CONFORMANCE WITH CSA B 111, FOR THE EXTERIOR LOCATIONS USE GALVANISED CONNECTORS AND PWF LUMBER
- PROVIDE MIN. 2 STRAPS AT EACH SIDE OF THE WINDOW AND STAIR OPENINGS.
- THE FOUNDATION CONTRACTOR SHALL NOTIFY ENGINEER OF ANY DISCREPANCY OR DEVIATION IN EXISTING CONDITION, PRIOR TO WORK PROCEEDING.
- ALL CANTILEVER AREA PROVIDE 2x6 NAILED AND GLUED TO EACH PERPENDICULAR JOIST PARALLEL TO WALL,
- 8. INSPECTION BY PROTECHGEO FOR CONFORMANCE TO ABOVE INSTALLATION REQUIREMENTS WILL NOT BE DONE UNLESS SPECIFICALLY REQUESTED BY CLIENT/OWNER.

ProtechGeo

6036 - Gateway Blvd, Edmonton, AB. T6H 2H6 E-mail: rsgill@protechgeo.com; Phone: 780-265-3790



PERMIT TO PRACTICE PROTECHGEO & MATERIAL, TESTING LTD. RM APEGA ID #: 13183

June 30, 2025 PERMIT NUMBER: P014414 The Association of Professional Engineers and Geoscientists of Alberta (APEGA)

THE CONTRACTOR SHALL CHECK AND VERIFY ALL DIMENSIONS AND OTHER DATA NOTED HEREIN WITH CONDITIONS ON SITE.

WRITTEN DIMENSIONS SHALL HAVE PRECEDENCE OVER SCALED DIMENSIONS

OF PROTECHGEO & MATERIAL TESTING LTD.

Drawing Title: LATERAL BRACING DESIGN

Client: ROMA HOMES PTG Project No.: 012825E03 Address: 27 MAPLE CRESCENT. LANDING TRAILS, GIBBONS, AB. Legal: LOT 25, BLOCK 31, PLAN 192 2297


Date: June 30, 2025


Scale: N.T.S

Drawn By: H.SIDHU

Drawing No.: LB STATUS.: PERMIT APPLICATION

Rev No.: 0

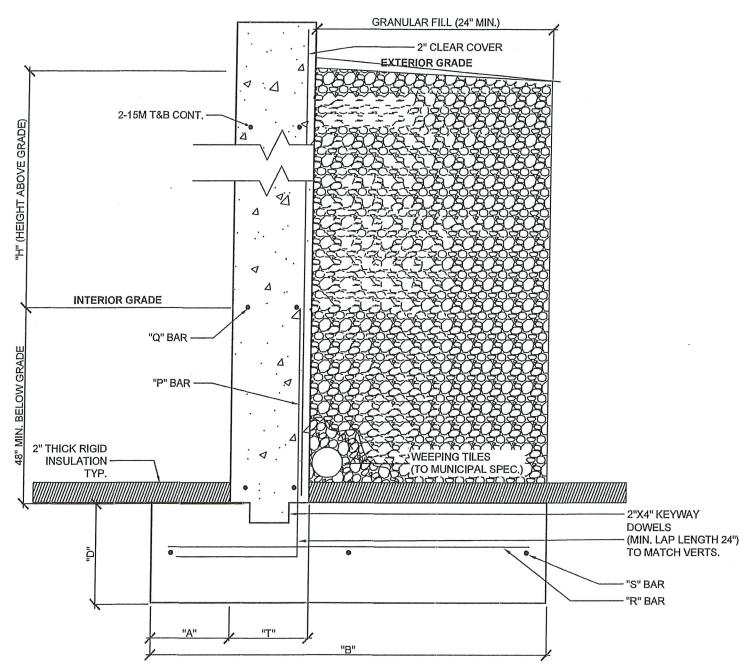

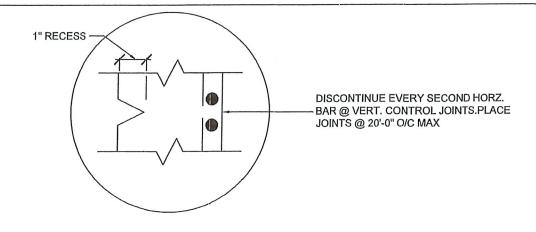

HEIGHT "H"	TOE LENGTH "A"	FOOTING WIDTH "B"	FOOTING THICKNESS "D"	WALL THICKNESS "T"	VERT. REINF. & BENT DOWELS "P" BAR	HORIZ. REINF "Q" BAR	FOOTING TOP REINF "R" BAR	FOOTING CONT. "S" BAR
2'-0"	0'-8"	2'-0"	0'-10"	0'-8"	15M @ 18"	15M @ 18"	N/A	2-15M CONT.
3'-0"	0'-8"	2'-0"	0'-10"	0'-8"	15M @ 18"	15M @ 18"	N/A	2-15M CONT.
4'-0"	0'-8"	3'-4"	0'-10"	0'-8"	15M @ 18"	15M @ 18"	15M @ 16"	3-15M CONT.
5'-0"	0'-8"	3'-4"	0'-10"	0'-8"	15M @ 18"	15M @ 18"	15M @ 16"	3-15M CONT.
6'-0"	0'-8"	4'-8"	1'-0"	0'-8"	15M @ 18"	15M @ 18"	15M @ 14"	5-15M CONT.
7'-0"	0'-10"	5'-6"	1'-0"	0'-8"	15M @ 14"	15M @ 18"	15M @ 14"	6-15M CONT.
8'-0"	1'-2"	6'-4"	1'-0"	0'-10"	15M @ 12"	15M @ 16"	15M @ 12"	6-15M CONT.

^{*} PROVIDE CONNECTION TO THE HOUSE FOUNDATION WALL HORIZONTAL REBARS, IF APPLICABLE (EMBED MIN 24" IN LENGTH)

DESIGN SPECIFICATIONS :-

- 1. CONCRETE
- 32 MPA TYPE 50 (HS) OR SPECIFIED IN SULPHATE TEST REPORT
- ALL CONCRETE EXPOSED TO FREEZE/THAW CYCLE HAS A MINIMUM AIR ENTRAINMENT OF 5-7%
- INTERNAL VIBRATION WITH A 31.8mm (1.25") MECHANICAL VIBRATOR
- MAXIMUM CONCRETE FORM PRESSURE (HURD, THUNMAN) 29kPa

2. REINFORCING STEEL

- IT IS DESIGNED TO CSA A23,3-94
- IT REINFORCES TO CSA CAN-A23.1-M90 AND CSA G30.12.M77
- ITS STRENGTH 400 Mpa
- 3. NO VEHICLE TRAFFIC OR BUILDING FOUNDATIONS TO BE LOCATED NEXT TO RETAINING WALL.
- 4. IT IS THE RESPONSIBILITY OF OTHERS TO CONFIRM CONSTRUCTION IS IN CONFORMANCE WITH DRAWING.
- IF THE DETAILS IN THIS DRAWING ARE NOT OR CANNOT BE FOLLOWED ACCURATELY PLEASE CALL FOR ADDITIONAL RECOMMENDATIONS.

ProtechGeo. Material Teating Ltd.

6036 - Gateway Blvd, Edmonton, AB. T6H 2H6 E-mail: rsgill@protechgeo.com; Phone: 780-265-3790



PERMIT TO PRACTICE PROTECHGEO & MATERIAL, TESTING LTD.

June 30, 2025

PERMIT NUMBER: P014414
The Association of Professional Engineers and
Geoscientists of Alberta (APEGA)

THE CONTRACTOR SHALL CHECK AND VERIFY ALL DIMENSIONS AND OTHER DATA NOTED HEREIN WITH CONDITIONS ON SITE.

WRITTEN DIMENSIONS SHALL HAVE PRECEDENCE OVER SCALED DIMENSIONS

DRAWINGS ARE PROPERTY OF PROTECHGEO & MATERIAL TESTING LTD.

Drawing Title: RETAINING WALL DESIGN

Client: ROMA HOMES PTG Project No.: 012825E03 Address: 27 MAPLE CRESCENT, LANDING TRAILS, GIBBONS, AB. Legal: LOT 25, BLOCK 31, PLAN 192 2297


Date: June 30, 2025

Scale: N.T.S Drawn By: H.SIDHU


Rev No.: 0

Drawing No.: RW STATUS.: PERMIT APPLICATION

DECK FOUNDATION PLAN

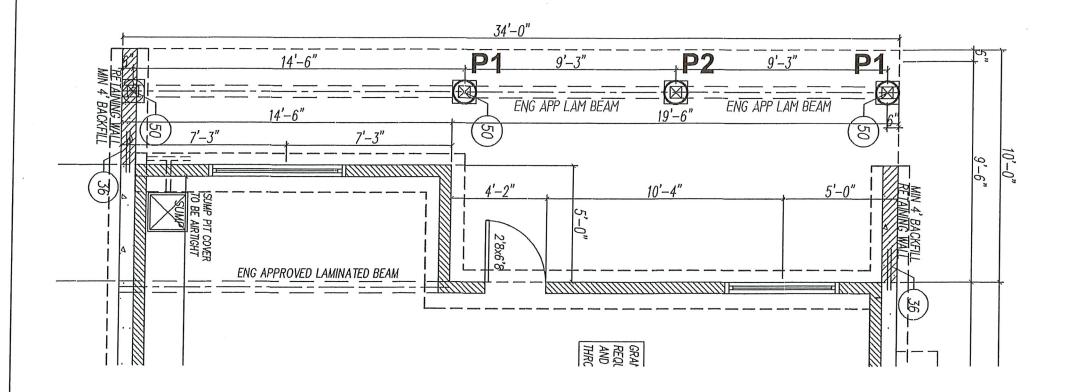

DECK SIDE ELEVATION

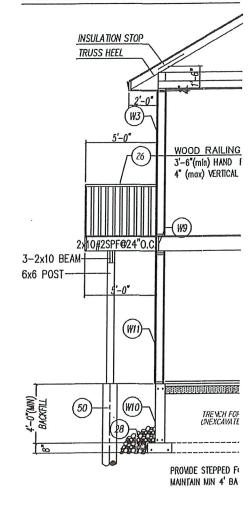

SCREW PILE SIZE AND TORQUES TO BE DETERMINED BY PILING CONTRACTOR BASED ON PILE SCHEDULE:

PILE SCHEDULE

P1: 12,000 lb(Factored)

P2: 6,000 lb(Factored)

Min Depth of Helix Below Ground: 10' CSA 40.20-13/G40.21-13

- ALIGN POST ON TOP OF PILE (DECK) WELDED STRUCTURAL QUALITY STEEL300MPa PILE INSTALLATION RECORDS MUST BE KEPT BY BUILDER AND PILING CONTRACTOR

ProtechGeo A Malurial Trilling Ltd

6036 - Gateway Blvd, Edmonton, AB. T6H 2H6 E-mail: rsgill@protechgeo.com; Phone: 780-265-3790



PERMIT TO PRACTICE PROTECHGEO & MATERIAL, TESTING LTD.

RM APEGA ID #: ___131831

June 30, 2025 **PERMIT NUMBER: P014414** The Association of Professional Engineers and

Geoscientists of Alberta (APEGA)

THE CONTRACTOR SHALL CHECK AND VERIFY ALL DIMENSIONS AND OTHER DATA NOTED HEREIN WITH CONDITIONS ON SITE.

- CONC. PILE UNDER DECK IS12" DIA. X14' DEEP R/F 2-15M VERT.REBARS

- DESIGN OF PILE BASED ON MIN. ALLOWABLE SKIN FRICTION OF15 kPa.

(BASED ON STIFF SOIL CONDITIONS, IF DIFFERENT SOIL CONDITIONS

ENCOUNTERED UNDERSIGNED SHOULD BE NOTIFIED).

- 32 MPa TYPE 50(HS) CONCRETE OR SPECIFIED IN SOIL REPORT

WRITTEN DIMENSIONS SHALL HAVE PRECEDENCE OVER SCALED DIMENSIONS DRA'MNGS ARE PROPERTY

OF PROTECHGEO &
MATERIAL TESTING LTD.

Drawing Title: COVERED DECK PILES

Client: ROMA HOMES PTG Project No.: 012825E03

Address: 27 MAPLE CRESCENT, LANDING TRAILS, GIBBONS, AB.

Legal: LOT 25, BLOCK 31, PLAN 192 2297

Date: June 30, 2025


Drawn By: H.SIDHU Scale: N.T.S

Drawing No.: PD

Rev. No.: 0

STATUS.: PERMIT APPLICATION

RESIDENTIAL CONCRETE FOUNDATION WALL WINDOW OPENINGS (WHERE OPENINGS ARE WIDER THAN 48" OR THE TOTAL WINDOW OPENINGS EXCEEDS 25% OF WALL LENGTH)

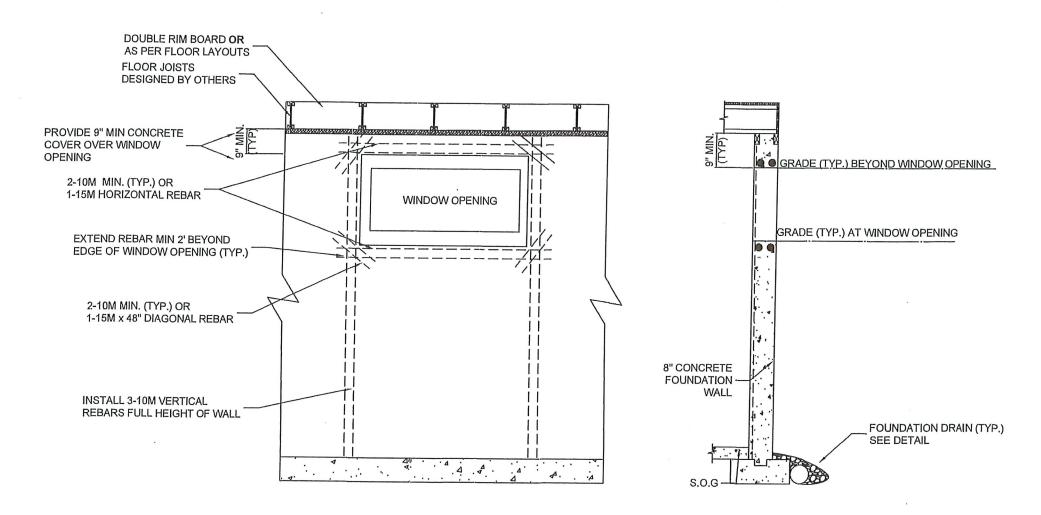

SPECIFICATIONS:

- PROVIDE A MINIMUM 9' DEPTH OF CONCRETE ABOVE WINDOW ROUGH OPENING FOR LINTEL
- INSTALL 2-10M (OR 1-15M) HORIZONTAL REBAR ABOVE AND 2-10M (OR 1-15M) REBAR BELOW EACH OPENING.
- EXTEND REBAR MINIMUM 2' 0" BEYOND THE SIDES OF EACH OPENING. WHERE OPENINGS ARE SPACED LESS THAN 3' 0" APART, USE FULL LENGTH BARS TO SPAN ACROSS ALL OPENINGS. IF HORIZONTAL BARS NEED TO BE LAPPED, PROVIDE 2'0" LAPPING BETWEEN BARS
- INSTALL 3-10M (OR 2-15M) VERTICAL REBAR ON BOTH SIDES OF WINDOW OPENING. PLACE BARS 6" APART ALONG INSIDE FACE FOR FULL HEIGHT OF WALL.
- INSTALL 2-10M (OR 1-15M) X 48" LONG REBAR DIAGONALLY AT EACH WINDOW CORNER TO REDUCE POTENTIAL TRANSVERSE CRACKING
- PLACE ALL REBARS A MINIMUM OF 2" FROM EDGE OF OPENING AND EXPOSED SURFACES,
- INSTALL DOUBLE LAYER OF ENGINEERED RIM BOARD OVER EACH WINDOW OPENING TO ADEQUATELY SUPPORT LOADS FROM ABOVE OR AS PER FLOOR SUPPLIER/FLOOR LAYOUTS
- PROVIDE LATERAL BRACING AT TOP OF WALL AS PER TYPICAL DETAILS WHERE JOIST ARE PARALLEL OR PERPENDICULAR TO CONCRETE WALLS.
- INSPECTION BY PROTECHGEO FOR CONFORMANCE TO ABOVE INSTALLATION REQUIREMENTS WILL NOT BE DONE UNLESS SPECIFICALLY REQUESTED BY CLIENT/OWNER.

ProtechGeo

6036 - Gateway Blvd, Edmonton, AB. T6H 2H6 E-mail: rsgill@protechgeo.com; Phone: 780-265-3790



PERMIT TO PRACTICE PROTECHGEO & MATERIAL, TESTING LTD. RM APEGA ID #: __131831

June 30, 2025 PERMIT NUMBER: P014414

The Association of Professional Engineers and Geoscientists of Alberta (APEGA)

THE CONTRACTOR SHALL CHECK AND VERIFY ALL DIMENSIONS AND OTHER DATA NOTED HEREIN WITH CONDITIONS ON SITE

WRITTEN DIMENSIONS SHALL HAVE PRECEDENCE OVER SCALED DIMENSIONS

DRAWINGS ARE PROPERT OF PROTECHGEO &

Drawing Title: WINDOW REINFORCEMENT DESIGN

Client: ROMA HOMES PTG Project No.: 012825E03

Address: 27 MAPLE CRESCENT, LANDING TRAILS, GIBBONS, AB.

Legal: LOT 25, BLOCK 31, PLAN 192 2297


Date: June 30, 2025

Scale: N.T.S Drawn By: H.SIDHU

Drawing No.: WR

STATUS.: PERMIT APPLICATION

Rev No.: 0

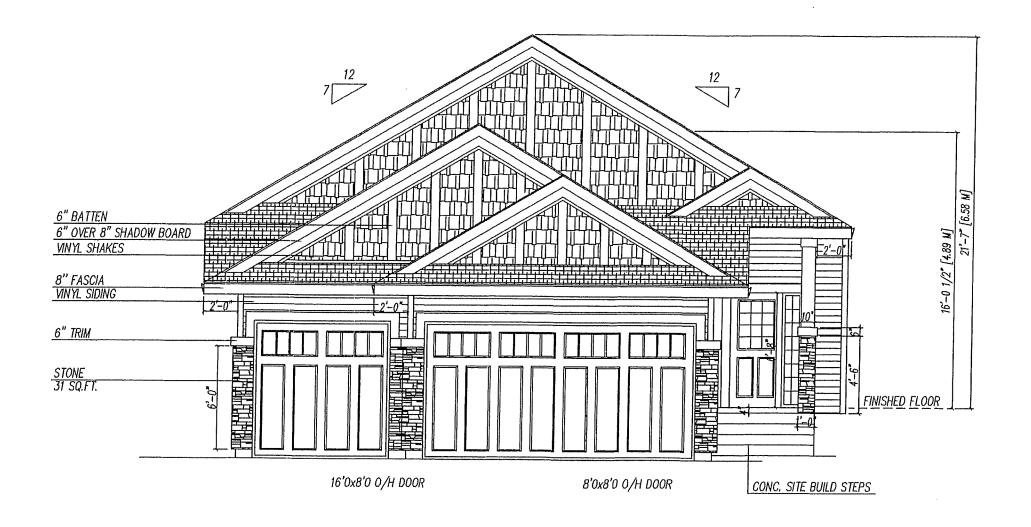

FRONT ELEVATION

HI-TECH DESIGNS
6734 75 ST MIV # 2 CANADA LTD.

6734 75 ST NW # 2 CANAL EDMONTON, AB, T6E 6T9 PHONE: (780) 450-4512 FAX: 1-888-872-6593 THESE PLANS, DESIGNS AND DETAILS ARE THE PROPERTY OF HI-TECH DESIGNS CANADA LTD. AND MAY NOT BE REPRODUCED IN WHOLE OR IN PART, WITHOUT WRITTEN CONSENT FROM HI-TECH DESIGNS. CCNITRACTOR / BUILDER SHALL VERIFY ALL SPECIFICATIONS AND DIMENSIONS BEFORE COMMENCING CONSTRUCTION AND REPORT ANY ERRORS OR OMISSIONS TO THIS OFFICE. ALL DIMENSIONS SHALL BE READ NOT SCALED.

LOT-25, BLOCK-31, PLAN-192 2297 LANDING TRAILS 27 MAPLE CRESCENT, GIBBONS

AREA

1716 SQ.FT.

BUILDER/CLIENT

ROMA HOMES


DESIGNED SCALE

3/16"=1'-0

DRAWN DRAWNG NO

DATE

1/7

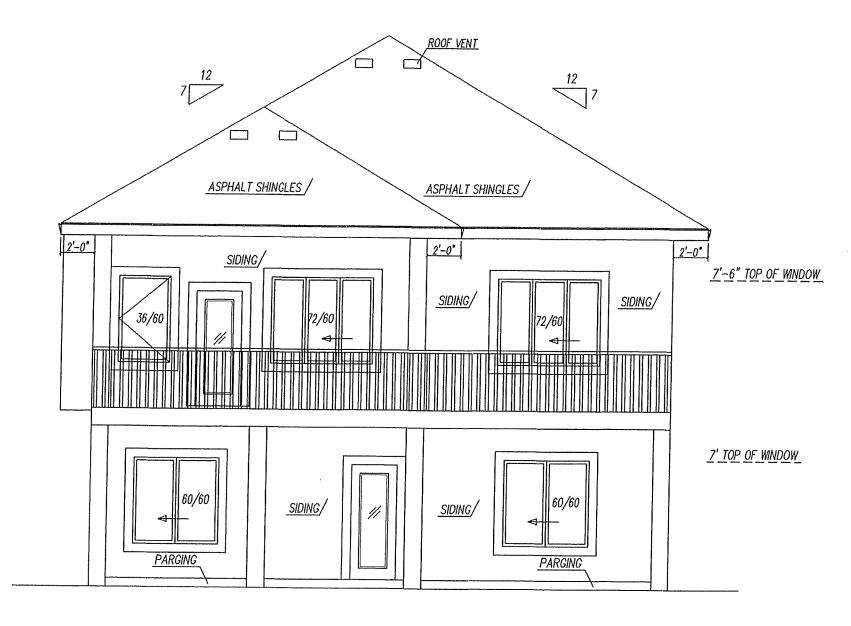

REAR ELEVATION

HI-TECH DESIGNS
6734 75 ST NIV # 2
EDMONTON, AB, T6E 6T9
PHONE: (780) 450-4512
FAX: 1-888-872-6593

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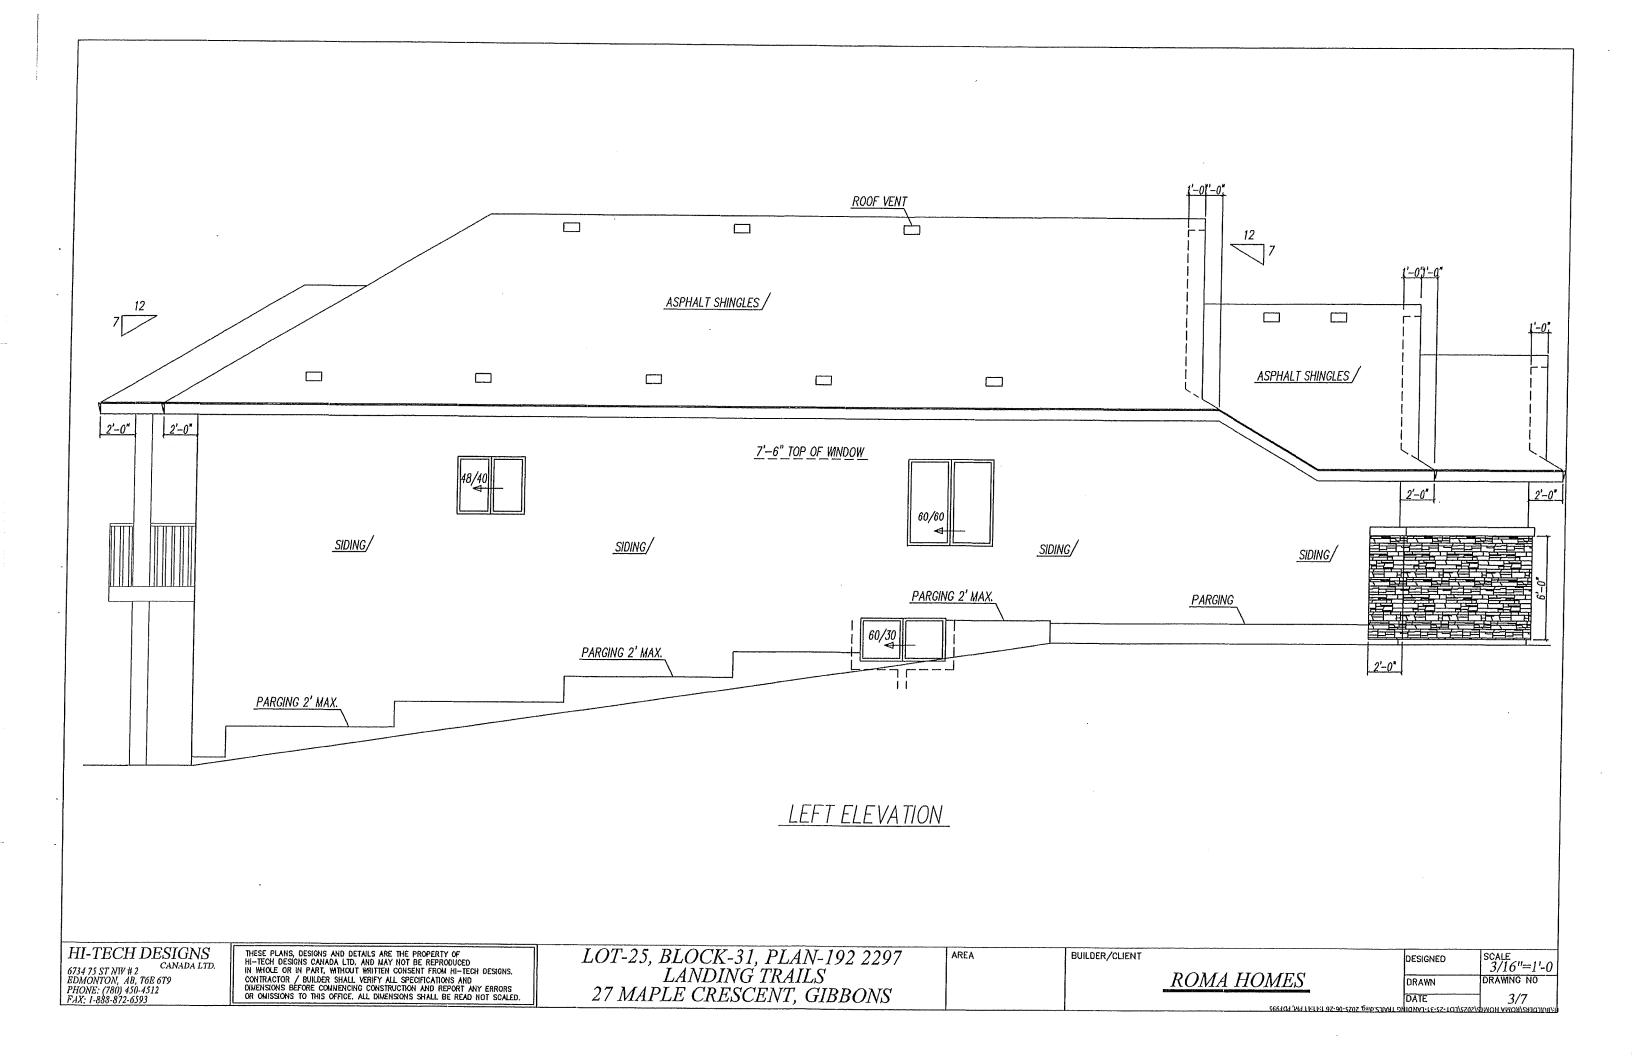
LOT-25, BLOCK-31, PLAN-192 2297 LANDING TRAILS 27 MAPLE CRESCENT, GIBBONS


AREA

BUILDER/CLIENT

ROMA HOMES


6404 WAZZLH:L 9Z-90-5Z0Z BAD:SVANL




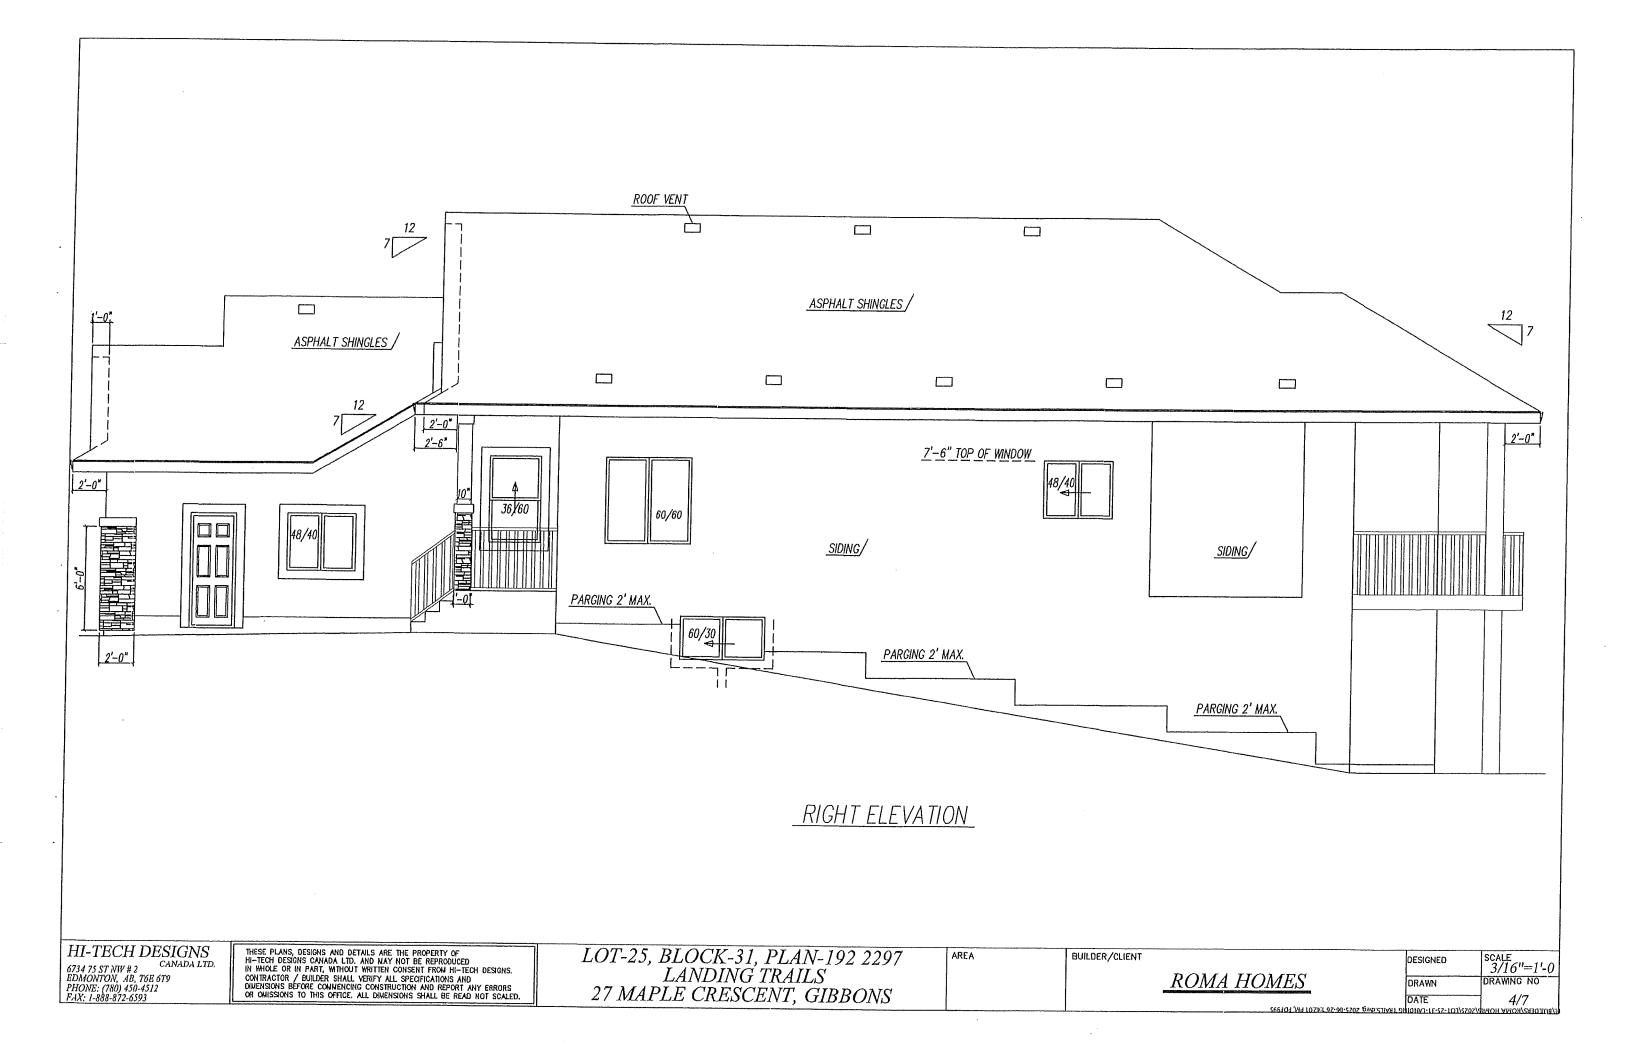

MAIN FLOOR PLAN 1716 SQ.FT. GARAGE 650 SQ.FT. 46'-10" 10'-0" 3'-0" 9'-0" 34'-10" 16'-0" 4'-6" 2'-4" 10'-6" UNIVENTED ALUMINUM 0.44mm THICK OR GRATER AS PER STANDATA 5'-4" GIRDER TRUSS IF SIDE YARD IS 1.2 M OR LESS 3-2"x10" #1 SPR. BEAM 10'-0" 3'0x6'8 2'0x6'8 5'-0" KITCHEN 8'10X16'0 4'-0" BEAM ROVED (10'-0" ENG CLOSET SMOKE/CO ALARM 17'-0' 7'-0" 4'-6" 2'8x6'8 2'8x6'8 SHELVES SHELVES GAS FIRE PLACE SMOKE ALARM 10'−0" 12" INDENT IN TRUSS SMOKE ALARM 2'6x6'8 2'6x6'8 48x36 WALK-IN CLOSET UNYENTED ALUMINUM 0.44mm THICK OR GRATER AS PER STANDATA IF SIDE YARD IS 1.2 M OR LESS 2'-6" 70'-10" LOT-25, BLOCK-31, PLAN-192 2297 LANDING TRAILS 27 MAPLE CRESCENT, GIBBONS HI-TECH DESIGNS THESE PLANS, DESIGNS AND DETAILS ARE THE PROPERTY OF HI-TECH DESIGNS CANADA LTD. AND MAY NOT BE REPRODUCED IN WHOLE OR IN PART, WITHOUT WRITTEN CONSENT FROM HI-TECH DESIGNS. AREA BUILDER/CLIENT SCALE 3/16"=1'-0 DESIGNED 6734 75 ST NW # 2 CAN EDMONTON, AB, T6E 6T9 PHONE: (780) 450-4512 FAX: 1-888-872-6593 CONTRACTOR / BUILDER SHALL VERIEY ALL SPECIFICATIONS AND DIMENSIONS BEFORE COMMENCING CONSTRUCTION AND REPORT ANY ERRORS OR OMISSIONS TO THIS OFFICE. ALL DIMENSIONS SHALL BE READ NOT SCALED. ROMA HOMES DRAWING NO DRAWN DATE 5/7

RAIL S. COZS-06-26 1:42.23 PM, PDP999

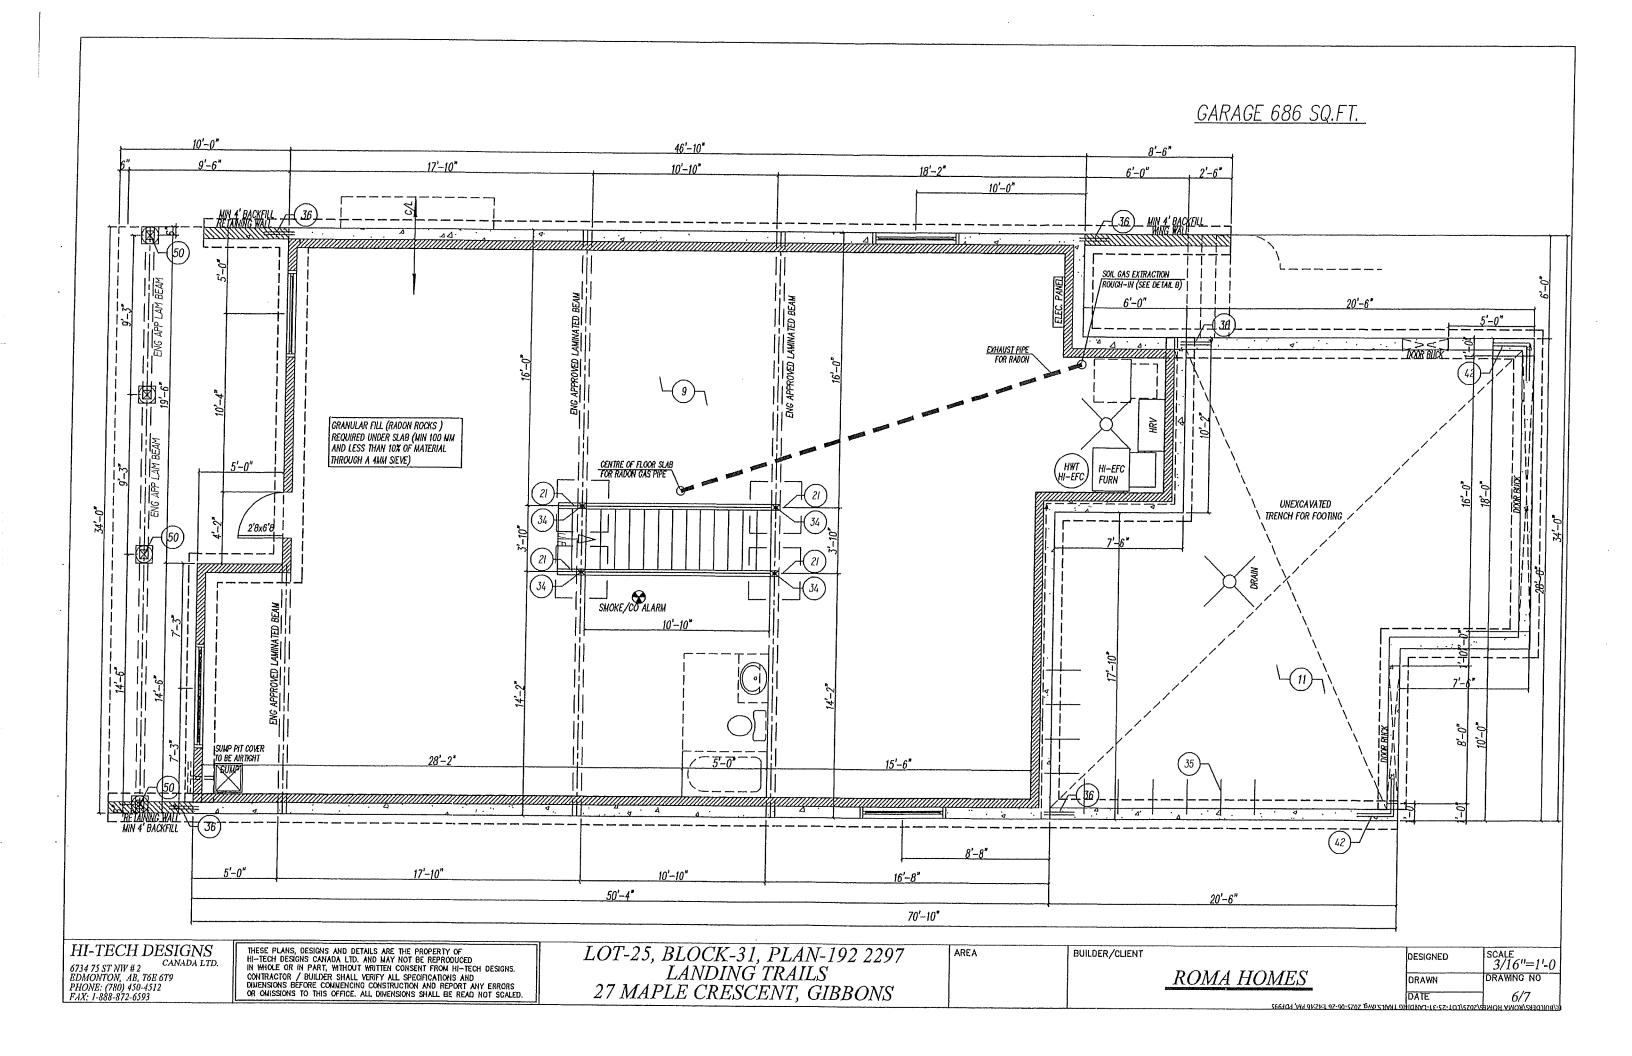

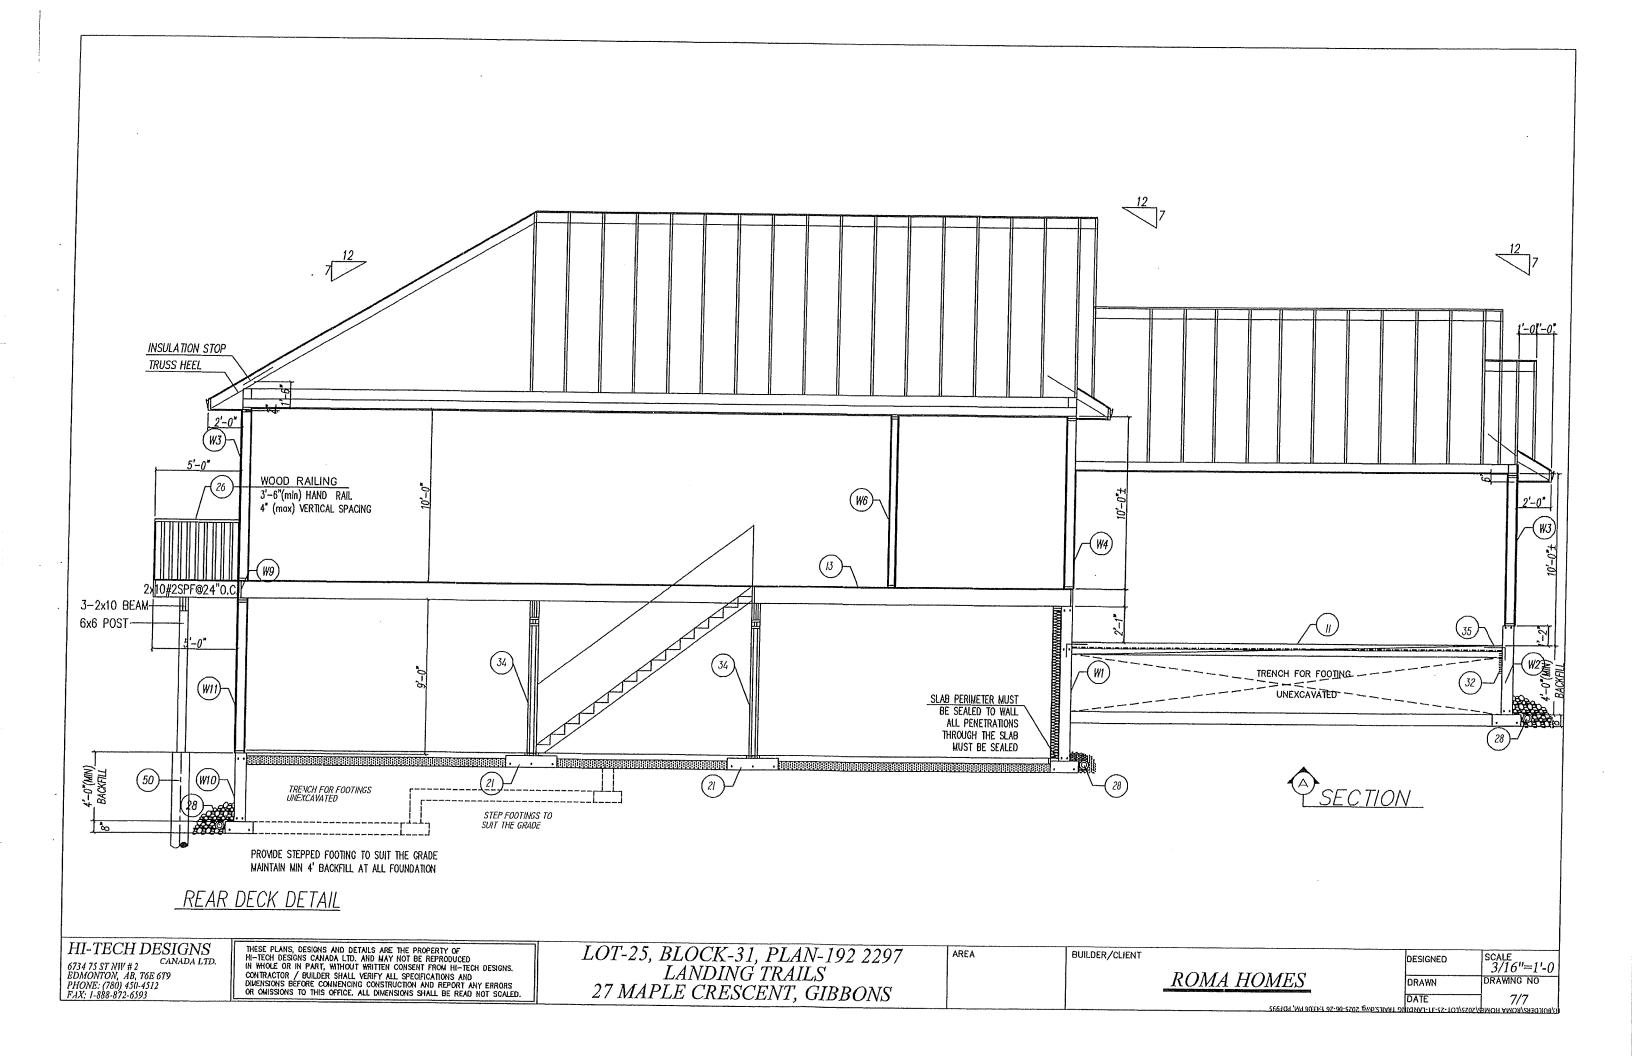

THE FOLLOWING LIST OF SPECIFICATIONS MAY NOT APPLY TO THE ATTACHED SET OF PLANS IN IT'S ENTIRETY.

- FOUNDATION WALL W/FOOTING (HOUSE)-SEE DETAIL WI 8" 32.5 MPA (min) CONCRETE WALL PARGING ABOVE GRADE DAMP-PROOFING BELOW GRADE ON 20"x8" 32.5 MPA(min) CONT. CONCRETE FOOTING R/F WITH 2-15M CONT.
 - FROST WALL SEE DETAIL WI ON APNDX-2
- (W2) FOUNDATION WALL W/FOOTING (GARAGE) 8" 32.5 MPA (min) CONCRETE WALL PARGING ABOVE GRADE DAMP-PROOFING BELOW GRADE ON 20"x8" 32.5 MPA(min) CONT. CONCRETE FOOTING R/F WITH 2-15M CONT.
- (W3) EXTERIOR WALL (HOUSE & GARAGE)-SEE DETAIL W3 SEE DETAIL W3 ON APNDX-2
- (W4) WALL (TO GARAGE) SEE DETAIL W4 SEE DETAIL W4 ON APNDX-2
- WALL (PARTITION) 1/2" GYPSUM BÓARD 2"x4" OR 2"X6" STUDS @ 24"0.C. 1/2" GYPSUM BOARD
- WALL (BEARING) 1/2" GYPSUM BOARD 2"x6" OR 2"X8" STUDS @ 16"0.C. 1/2" GYPSUM BOARD
- WALL (BEARING) W/FOOTING 1/2" GYPSUM BOARD 2"x6" STUDS @ 16"0.C. 1/2" GYPSUM BOARD ON 18"x8" 32.5MPA(min) CONT.CONCRETE FOOTING R/F WITH 2-15M CONT.
- (W8) TALL WALL-SEE DETAIL W8
- (W9) RIM BOARD ASSEMBLY SEE DETAIL W9
- WALKOUT FOUNDATION AND UNHEATED FLOOR ABOVE FROST LINE
- (WI) FOUNDATION WALKOUT EXTERIOR WALL-SEE DETAIL WII

- 4"20MPA (min) CONCRETE SLAB NOT LESS THAN 100mm OF COARSE CLEAN GRANULAR MATERIAL(RADON ROCKS) CONTAINING NOT MORE THAN 10% OF MATERIAL THAT WILL PASS A 4 mm SIEVE SHALL BE PLACED BENEATH FLOOR-ON-GROUND.
- ## 27.5 MPA (min) CONCRETE SLAB
 R/F WITH 6 x8 Bgaww
 6mil POLY
 6 (min) WELL COMPACTED PIT RUN SAND
 SLOPED TO FRONT 3"(min)
- FLOOR (UPPER LEVEL) FLOOR (UPPER LEVEL)
 FINISHING FLOOR MATERIALS
 5/16" PLYWOOD UNDERLAY
 5/8" T.&G. PLYWOOD OR 3/4"OSB SUBFLOOR
 DOUGLAS FIR #1&2 OR 1 JOISTS
 AS PER FLOOR PLANS
 2"22" X—BRIDGING @ 7'-0"O.C.(max)
 1/2" GYPSUM BOARD
- FLOOR (MAIN LEVEL)
 FINISHING FLOOR MATERIALS
 5/16" PLYWOOD UNDERLAY
 5/8" T.&C. PLYWOOD OR 3/4"OSB SUBFLOOR
 DDUGLAS FIR #1&2 OR JOISTS
 AS PER FLOOR PLANS
 2"x2" X—BRIDGING © 7'-0" O.C. (max)
- ROOF (TRUSS) ROOFING AS PER ELEVATION
 BUILDING PAPER
 APPROVED TRUSSES © 24" OR 16" O.C.
 AS PER FLOOR PLANS CELLULOSE FIBER INSULATION R52
 6mil POLY
 1/2" CEILING BOARD
 C/W 1" FASCIA BOARD
 G.I. EAVESTROUGH & R.W.L. TO STORM LINE
 SOFFIT VENTED
- ROOF (FOR DETACHED GARAGE AND COVERED DECK ONLY) ROOFING AS PER ELEVATION BUILDING PAPER

APPROVED TRUSSES @ 24" OR 16" O.C. AS PER FLOOR PLANS LOOSE FILL R-40 INSULATION II POLY CEILING BOARD W 1" FASCIA BOARD EAVESTROUGH & R.W.L. TO STORM LINE FIT VENTED

- ROOF (RAFTER) ROOFING AS PER ELEVATION BUILDING PAPER
 - DOUGLAS FIR #1&2 RAFTERS OR I JOISTS AS PER FLOOR PLANS 2"X4" STRAPPING © 24"O.C. PERPENDICULAR TO AND ON TOP OF RAFTERS FRICTION FIT R-52 CELLULOSEFIBER INSULATION 6mil POLY 1/2" GYPSUM BOARD
- GRADE BEAM WITH 2-15M CONT. TOP & BOTTOM
- FOOTING SIZING VARIES AS PER ENGINEERED COLUMN SPECIFICATION

- 7 7/7"(max) RISE 10"(min) RUN 11"(min) THREAD 1" NOSING 6'-6"(min) HEAD ROOM 3'-0" RAIL AT LANDING & STAIR 4" (MAX) VERTICAL SPACING 1/2" GYPSUM BOARD FOR INSULATED STAIRWELLS ONLY
- 12'0 14'-0" DEEP 32.5 MPA (mln) CONCRETE PILE R/F WITH 3-15M VERTICAL
- 1670 16'-0" DEEP 25MPA (min) CONCRETE PILE R/F WITH 4-15M VERTICAL 10M TIES @ 16"0.C.
- RAILING 3'-6"(min) HAND RAIL 4"max) VERTICAL SPACING
- WASHER / DRYER PROVIDE HOT & COLD WATER TAPS AND STAND PIPE FOR WASHER VENT DRYER TO EXTERIOR
- 870 METAL FLUE 2"(min) CLEARANCE TO ALL WOOD
- '-8"x 6'-8"(min) DOOR /W SELF-CLOSER AND WEATHER STRIPPING
- INSULATION 2"RIGID INSULATION
- 33 POST
 370 ADJUSTABLE STEEL POST
- POST ENGINEERED COLUMN SIZED TO SUIT LOAD
- 27x6" SOLID BLOCKING @ 48" O.C. AND @ TIER POINTS 15M DOWELS @ 24 O.C. ALL AROUND
- 36 DOWEL 2-20M DOWELS TOP & BOTTOM
- 8"x 18"x10"25 MPA (min) CONCRETE FOOTING
- 870 8'-0" DEEP 25MPA (mln) CONCRETE PILE R/F WITH 1-10M VERTICAL
- DOWEL
 2-15M 24" x 24" CORNER BARS TOB 9 BOTTOM
- GRADE BEAM 8"x20 1/2" 25MPA (min) CONT. CONCRETE GRADE BEAM R/F WTH 2-15M CONT. TOP & BOTTOM 10M TIES 0 24"O.C. C/W 4" VOID FORM
- PILE 12"O 12'-0" DEEP 25MPA (min) CONCRETE PILE R/F WITH 3-10M VERTICAL
- METAL SCREW PILE (50)-SEE MANUFACTURER DETAIL

GENERAL NOTES:

ALL WORK AND MATERIALS TO COMPLY WITH THE REQUIREMENTS OF THE BUILDING CODE

ALL SIZES & DIMENSIONS TO BE CONFIRMED BY THE GENERAL CONTRACTOR ANY DISCREPANCIES TO BE REPORTED TO THIS OFFICE OFFICE CLARIFICATION AGREED UPON BEFORE PROCEEDING

FOUNDATION WALLS OF POURED CONCRETE TO BE 8" THICK AND EXTEND A MINIMUM OF 6" ABOVE FINISHED GRADE REINFORCED WITH 2 ROWS OF 2-10M. WALLS SHALL BE DAMPROOFED WITH HEAVY COAT OF BITUMINOUS OR OTHER DAMPPROOFING MATERAL.

BASEMENT WINDOWS SHALL BE REINFORCED AS PER ENGINEERED DETAIL

CONCRETE STRENGTH SHALL NOT BE LESS THAN 20 MPa (2900 psi.) AFTER 28 DAYS WITH AIR ENTRAINMENT OF 5 to 8 pércent.

ATTIC ACCESS TO BE AT LEAST 20"X28"C/W WEATHER STRIPPING AND INSULATION TH BUILDING SITE SHALL BE GRADED SO THAT SURFACE WATER SHALL NOT ACCUMULATE AT OR NEAR THE BUILDING

END BEARING OF JOISTS AND RAFTERS SHALL NOT BE LESS FLOOR & CEILING JOIST BRIDGING AS PER ENGINEERED DETAIL

CONTINIOUS WOOD STRAPPING AND IS TO CONSISTS OF CROSS BRIDGING, SOLID BLOCKING OR DOUBLE FRAMING UNDER ALL PARALLEL PARTITIONS AND AROND ALL OPENINGS

BUILT-UP BEAMS SHALL ONLY HAVE SPLICES IN ALTERNATE POINT PAST A POST, EXCEPT AT BEAM ENDS.

FIRE STOPS ARE TO BE PROVIDED AT ALL CONCEALED SPACES @ FLOOR, CEILING & ROOF LEVELS INCLUDING THE SPACE BETWEEN THE CHIMNEY FLUE AND SHAFT WHERE IT PASSES THROUGH FLOOR OR CEILING.

PROVIDE BUILT-UP POSTS OF A WIDTH EQUAL TO THE WIDTH OF BEAM, WHERE FRAMED INTO INTERIOR OR EXTERIOR WALLS.

ROOF OR ATTIC SPACES IS TO BE PROVIDED WITH AN UNOBSTRUCTED VENT AREA OF NOT LESS THAN OF THE INSULATED CEILING AREA, DISTRIBUTED TO PROVIDE GOOD CROSS VENTILATION.

EXHAUST FROM KITCHEN ARE WASHROOM FANS IS TO BE DUCTED DIRECTLY TO THE OUTSIDE & DUCT IS TO BE INSULATED THROUGH UNHEATED SPACE COMBUSTION AIR IS REQUIRED FOR ALL FUEL FIRED HEATING APPLIANCES INCLUDING FIRE PLACES INTRODUCD BY INTAKES OTHER THAN A DOOR OR WINDOW

ALL COMMON HOUSE/ GARAGE WALLS, CEILING AND FLOORS SHALL BE ONE HOUR FIRERATED.

FOR ATTACHED GARAGES, ANY COMMON WALL IS TO PROVIDE AN EFFECTIVE BARRIER AGAINST THE PASSAGE OF GAS AND EXHAUST FUMES. ANY DOOR IS TO BE TIGHT FITTING. WEATHER STRIPPED ,AND FITTED WITH SELF CLOSING DIMCE.

AVOID PACKING CANTILEVERS FULL OF INSULATION I FAVE AN AIR SPACE BETWEEN SUBFLOOR AND INSULATION FOR WARM AIR CIRCULATION

INSULATION AND THE BOTTON OF THE ROOF SHEATHING FOR ADEQUATE ROOF VENTILATION


AT THE INTERSECTION OF ROOFS PROVIDE SHEET METAL FLASHING OF ATLEAST 0.013" THICK GALVANIZED STEEL OR OTHER ACCEPTABLE MATERIAL

USE 1/2" CD DRYWALL OR 5/8" DRYWALL WHERE TRUSSES ARE GREATER THAN 16" O.C. A SMOKE ALARM INSTALLED BY PERMANENT CONNECTIONS TO A ELECTRICAL CIRCUIT IS TO BE PROVIDED BETWEEN ALL SLEEPING AREAAS AND THE REMAINDER OF THE HOUSE

NON HARDENING CAULKING COMPOUND TO BE USED OVER AND AROUND ALL EXTERIOR OPENINGS PLUMBING ACCESS OF 16"X20" TO BE PROVIDED FOR TUBS AND SHOWERS PROVIDE FRESH AIR INTAKES FOR FUR NACES AND FIREPLACES

ALL WORKMANSHIP TO BE A STANDARD EQUAL IN ALL RESPECTS TO GOOD BUILDING PRACTICE SIDDING/ STUCCO TO BE 6" ABOVE FINISH GRADE ALL LINTLES TO BE 3-2"X12" FINISH WOOD RAILINGS, PICKETS MAXIMUM 4" O.C. PRECAST CONCRETE STEPS.

CAPED DRYER VENT INSULATED ATTIC ACCESS HATCH-20"X28" LINEN CLOSET -4 SHELVES MIN, 1'-2" DEEP WASHROOMS TO BE MECHANICALLY VENTED TO STAIR SUPPORT TO BE 4"X4" KILN DRIED SPRUCE POST ON 24"X 24"X 8" CONCRETE FOOTING PROVIDE @AT LEAST ONE AIR EXCHANGE PER HOUR

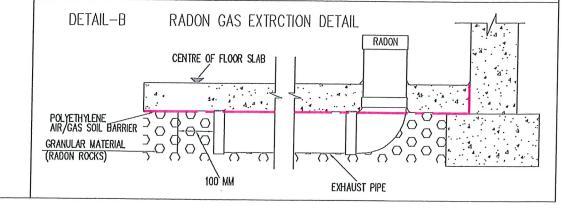

HI-TECH DESIGNS REVISED CANADA LTD. 6734 75 ST NW # 2 EDMONTON, AB, T6E 6T9 PHONE: (780) 450-4512 FAX: 1-888-872-6593

2021-06-12

APNDX-

PRESCRIPTIVE REQUIREMENTS (SIDING) THERMAL RESISTANCES FOR ZONE 7A WITH HRV.

(W) FOUNDATION WALL W/FOOTING (HOUSE) RSI 2.98 REQUIRED W/HRV TABLE A-9.36.2.8.(1)C, A-9.36.2.4.(1)D

8" CONCRETE WALL 2"x6"STUDS @ 24"O,C. &R-20 BATT INSULATION 6mil POLYETHYLENE SHEET INTERIOR AIR FILM	RSI VALUE 0.08 2.81 0.12
EFFECTIVE VALUE	3.01

(W3) EXTERIOR WALL (HOUSE & GARAGE) RSI 2.97 REQUIRED W/HRV TABLE A-9.36.2.6.(1)9, A-9.36.2.4.(1)0

OUTSIDE AIR FILM SIDING SHEATHING PAPER 3/8" (9.5mm) OSB SHEATHING 2"x6"STUDS @ 24"O.C. &R-22 BATT INSULATION	RSI VALUE 0.03 0.11 0.09 2.67
6mii Polyethylene sheet Gypsum Board Interior air film	 0.08 0.12
EFFECTIVE VALUE	3.10

WALL (TO GARAGE) RSI 2.97 REQUIRED W/HRV TABLE A-9.36.2.6.(1)8

Interior air film Gypsum Board 6mil Polyethylene Sheet	RSI VALUE 0.12 0.08
2"x6"STUDS © 19.2"O.C. (21.5%) &R-24 BATT INSULATION (78.5%)	2.73
AIR BARRIER 5/8" FIRE RATED GYPSUM BOARD	0.10
EFFECTIVE VALUE	3.03

W8 TALL WALL RSI 2.97 REQUIRED W/HRV TABLE A-9.36.2.6.(1)B, A-9.36.2.4.(1)D

OUTSIDE AIR FILM SIDING SHEATHING PAPER 3/8" (9.5mm) OSB SHEATHING 2"x6"0 8"0.C.&R24 2"x6"0 12"0.C.&R24 2"x6"0 16"0.C.&R22 (SEE ENGINEER REPORT)	RSI V/ 0.03 0.11 0.09 2.54	2.60	2,55
6mil Polyethylene Sheet 1/2" Gypsum Board Interior Air Film EFFECTIVE VALUE	0.08 0.12 2.97	3.03	2.98

RIM BOARD ASSEMBLY, BATT INSULATION, RSI 2.97 REQUIRED W/HRV TABLE 9.36.2.6.B

MAIN FLOOR	
OUTSIDE AIR FILM SIDING SHEATHING PAPER 3/8" (9.5mm) OSB SHEATHING 1 1/8" PRE-INSULATED RIN BOARD	RSI VALUE 0.03 0.11 0.09 0.26
11 7/8" ENC. FLOOR ↓CISTS@ 19.2" O.C.(11.5%) + R20 BATT INSULATION(88.5%)	3,35
6mil Polyethylene sheet	
EFFECTIVE VALUE	3.84

UPPER FLOOR-PERPENDICULAR TO JOISTS RSI VALUE OUTSIDE AIR FILM 0.03 0.11 SHEATHING PAPER 3/8" (9.5mm) OSB SHEATHING 0.09 3 1/2" Insulated Pony Wall R-20 Batt Insulation 3.52 6mil POLYETHYLENE SHEET __ EFFECTIVE VALUE 3.75

UPPER FLOOR-PARALLEL TO) Joists
OUTSIDE AIR FILM SIDING SHEATHING PAPER 3/8" (9.5mm) OSB SHEATHING	RSI VALUE 0.03 0.11 0.09
2"x6"STUDS @ 24"O.C. &R-22 BATT INSULATION	2.67
6mil Polyethylene sheet Gypsum Board Interior air film	0.08 0.12
EFFECTIVE VALUE	3.10

CEILING BELOW ATTIC RSI 8.67 REQUIRED W/HRV TABLE A-9.36.2.4.(1)A, A-9.36.2.4.(1)D

ſ			
	OUTSIDE AIR FILM	RSI VALUE 0.03	
	R39 CELLULOSE FIBER INSULATION CONTINIOUS RSI	6.84 OVERALL R VALUE	
	2X4 BOTTOM CHORD @ 24"O.C.(7%) 3.5" CELLULOSE (RSI 2.22, R13)(93%)	0F INSULATION R52	
	6mii Polyethylene Sheet 1/2" Ceiling Board Interior air film (heat flow up)	 0.077 0.11	
	EFFECTIVE VALUE	9.04	

FLOOR OVER UNHEATED SPACE RSI 5.02 REQUIRED W/HRV TABLE A-9.36.2.4.(1)A, A-9.36.2.4.(1)D

INTERIOR AIR FILM (HEAT FLOW DOWN) FLOOR FINISH SUBFLOOR 11 7/8" ENG. FLOOR JOISTS 6mil POLYETHYLENE SHEET GYPSUM BOARD AIR GAP	RSI VALUE 0.16 0.17 0.08 0.16
2XIO FRAME @24" O.C.(10%) & R-30 BATT INSULATION(90%)	4.54
GYPSUM BOARD OUTSIDE AIR FILM	0.08 0.03
EFFECTIVE VALUE	5.22

(M) FOUNDATION WALKOUT EXTERIOR WALL RSI 2.97 REQUIRED W/HRV TABLE A-9.36.2.6.(1)B, A-9.36.2.4.(1)D

-	• •
OUTSIDE AIR FILM SIDING SHEATHING PAPER 3/8" (9.5mm) OSB SHEATHING	RSI VALUE 0.03 0.11 0.09
2"x6"STUDS © 16"O.C. &R-22 BATT INSULATION	2.55
6mii polyethylene sheet Gypsum board Interior air film	 0.08 0.12
EFFECTIVE VALUE	2.98

CANTILEVER - SEE DETAIL ON APNDX-5 RSI 5.02 REQUIRED W/HRV TABLE A-9.36.2.4.(1)A, A-9.36.2.4.(1)D

	RSI VALUE
INTERIOR AIR FILM (HEAT FLOW DOWN)	0.16
FLOOR FINISH SUBFLOOR	0.17
	0.17
11 7/8" ENG. FLOOR JOISTS® 19.2" O.C.(11.5%) + R30 BATT INSULATION(88.5%)	4.65
5/8" PLYWOOD OR OSB SHEATHING	0.135
OLO CAPITAL CAPE	
SHEATHING PAPER NON VENTED METAL SOFFIT	
OUTSIDE AIR FILM	0.03
	0,00
EFFECTIVE VALUE	5.15

NOTES:

ALL WINDOWS MAX USI 1.60, ALTERNATIVE: MIN ER=25 ALL EXTERIOR DOORS MAX USI 1.60 SINGLE EXTERIOR DOOR EXCEPTION MAX USI 2.60

MATERIALS INTENDED TO PROVIDE THE PRINCIPAL RESISTANCE TO AIR LEAKAGE CONFORM TO CAN/ULC-S741.

COMPONENT/EQUIPMENT	HEATING/COOLING CAPACITY	STANDARD	MIN PERFORMANCE
GAS-FIRED FORCED AIR FURNACE	<65.9k\\[222,000Btu/h]	CAN/CSA-P.2	>=AFUE 92%
COMPONENT	INPUT	STANDARD	PERFORMANCE REQ'T

<22kW[75,000Btu/h]

NOTE: FOR ZERO-LOT-LINE LOT REPLACE WITH 3/8" (9.5mm) OSB SHEATHING RSI(0.093) OR 1/2" GLASS-MAT SHEATHING RSI (0.09)


GAS-FIRED HOT WATER TANK


HI-TECH DESIGNS 6734 75 ST NW # 2 EDMONTON, AB, T6E 6T9 PHONE: (780) 450-4512 FAX: 1-888-872-6593 CANADA LTD.


REVISED

2021-06-12

CAN/CSA-P.3 | EF>=0.67-0.0005V

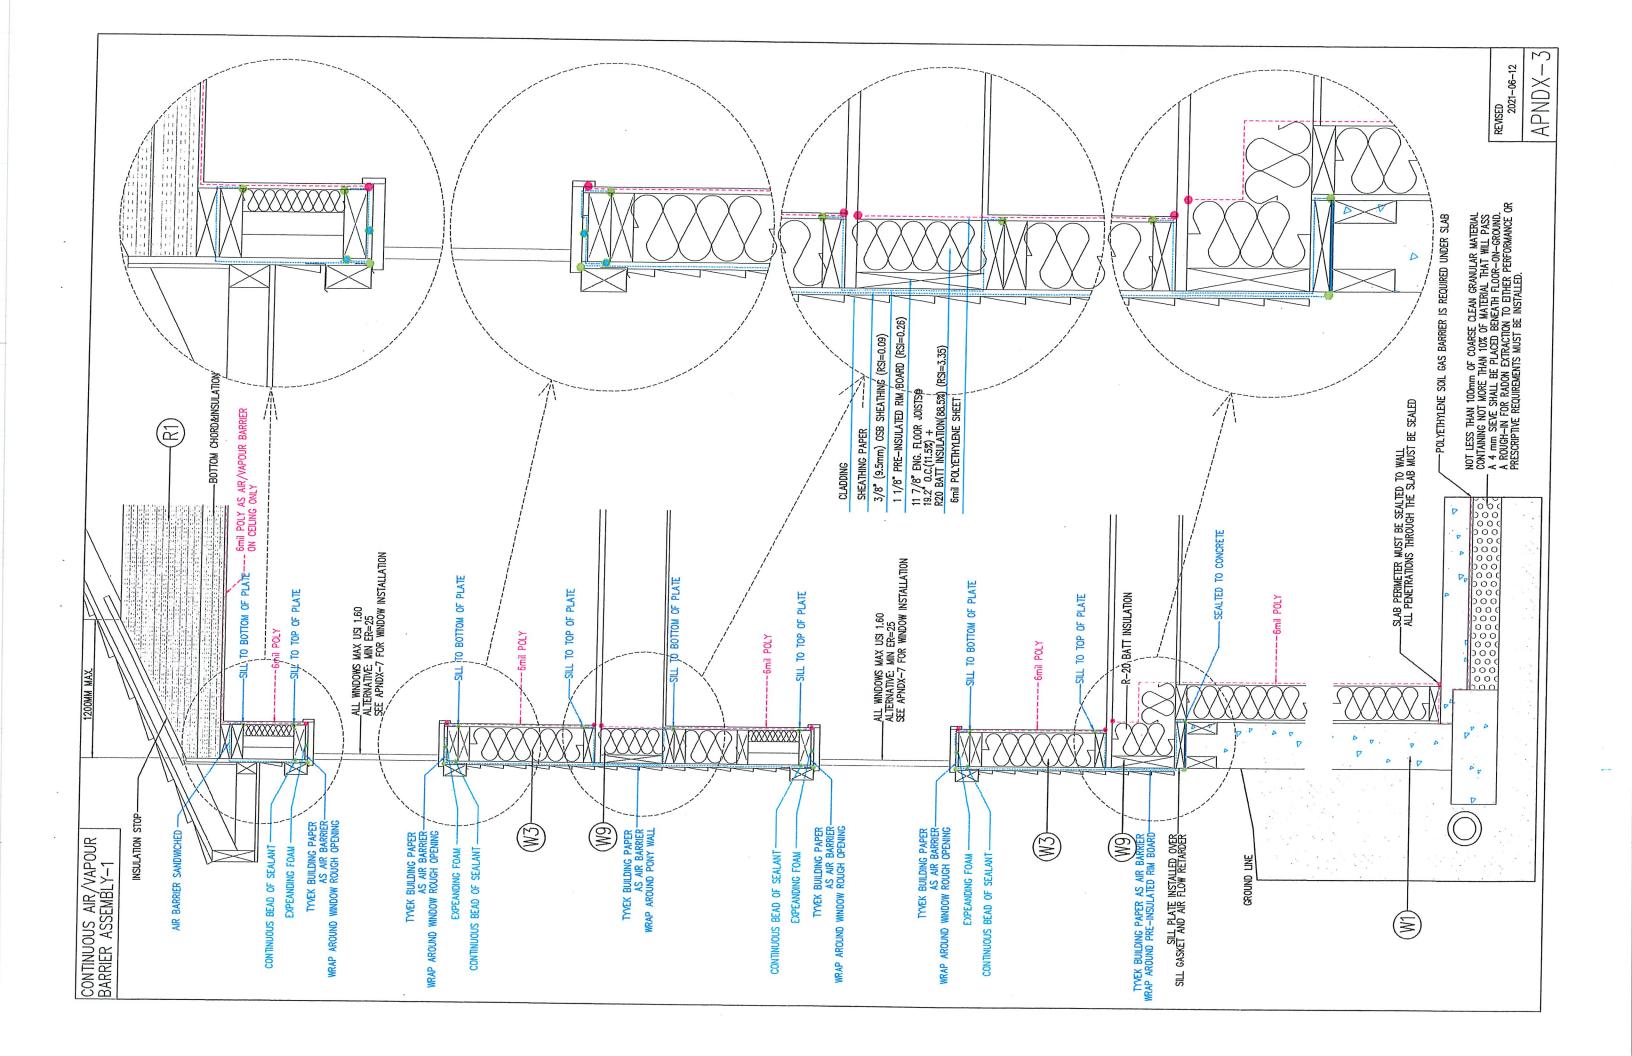

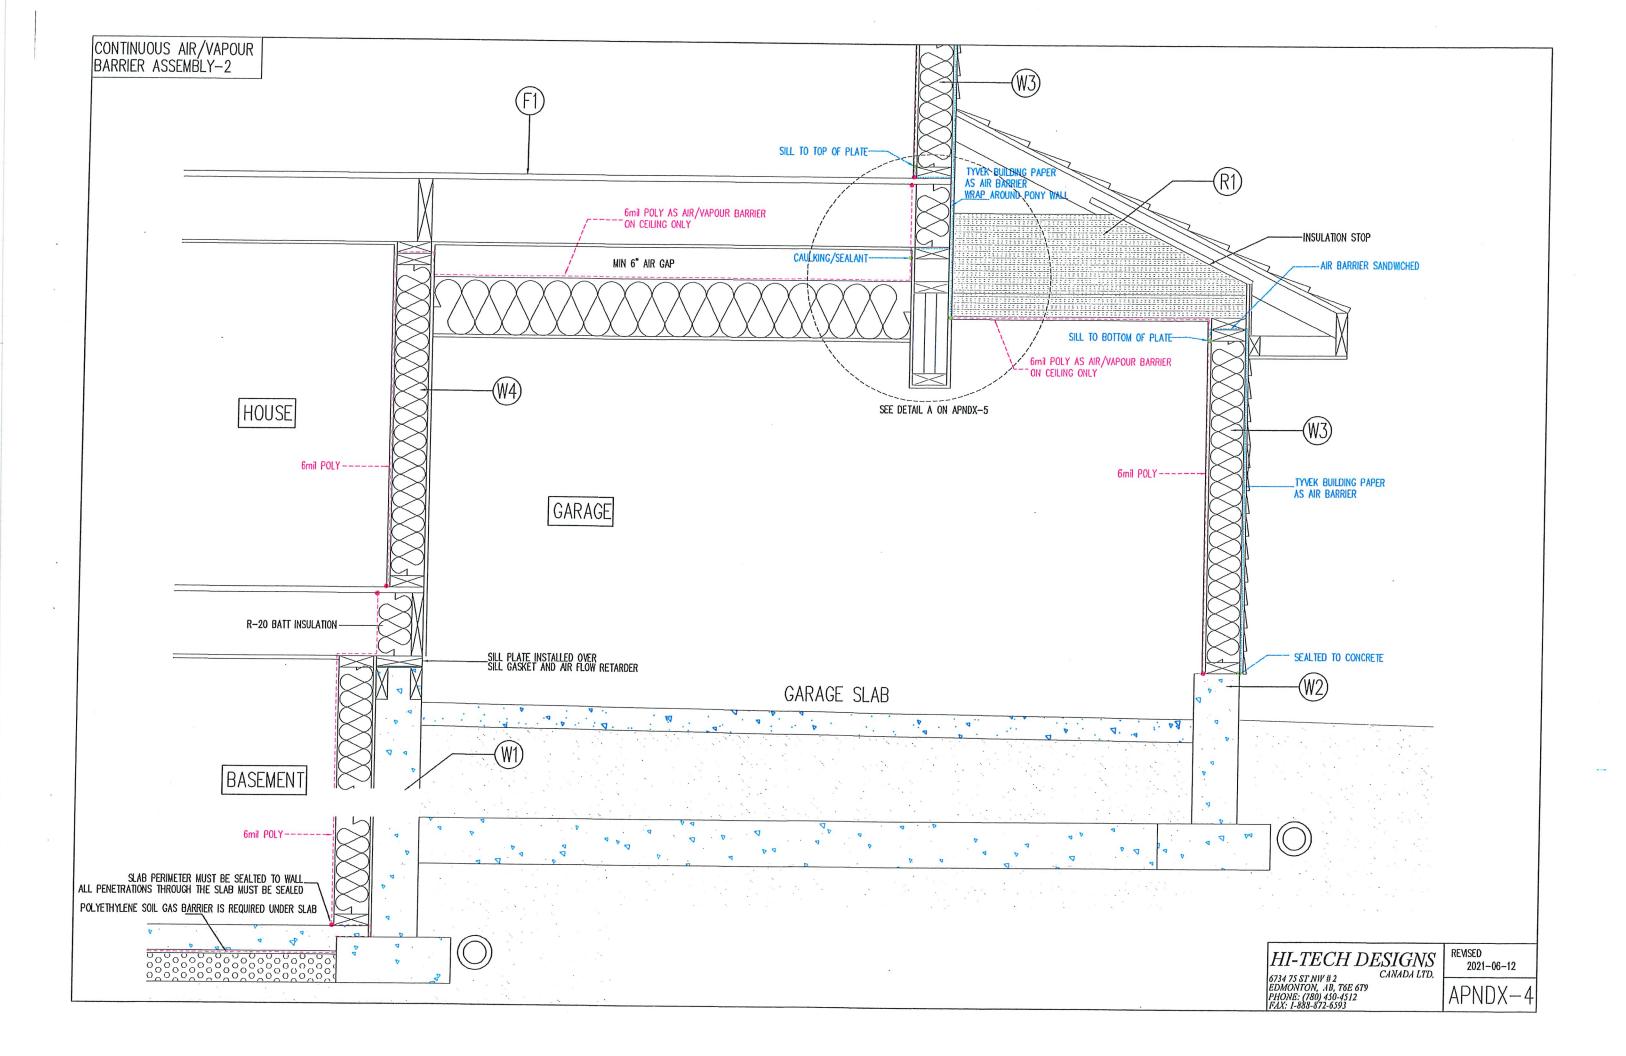

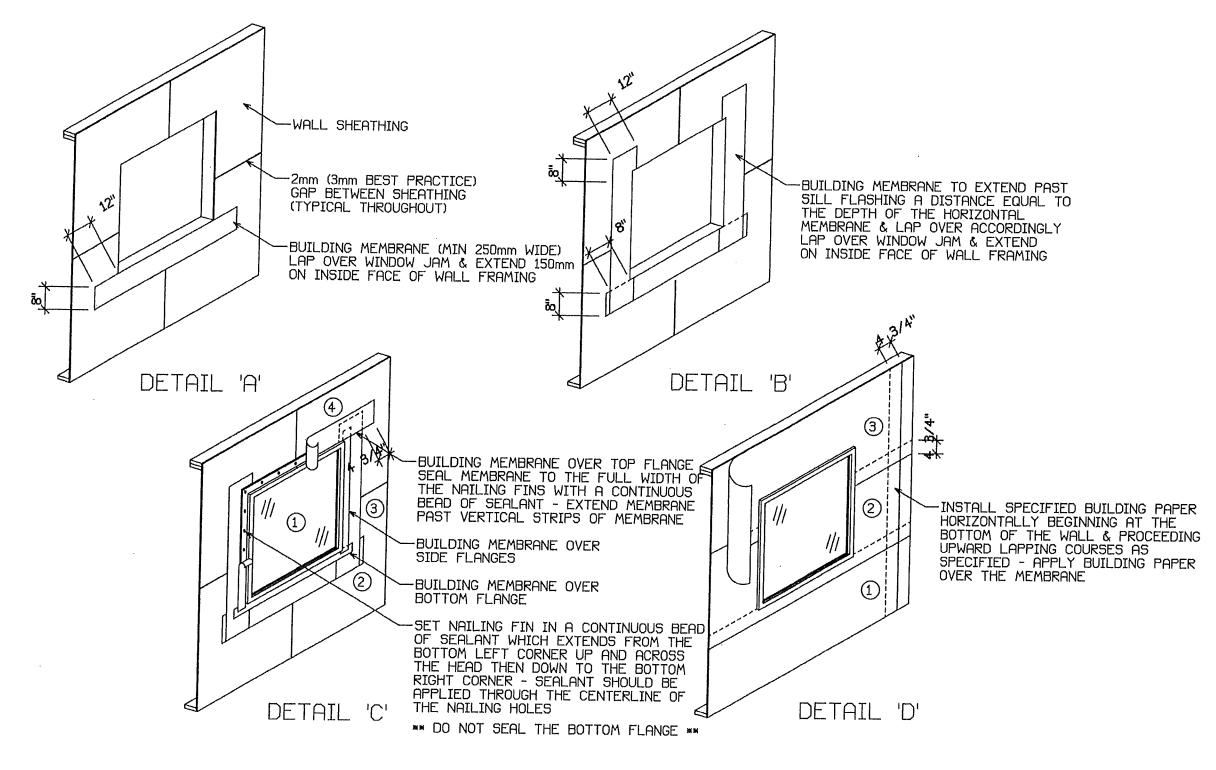


WINDOW INSTALLATION, WALL SHEATHING & WALL SHEATHING MEMBRANE DETAILS

HI-TECH DESIGNS
6734 75 ST NW # 2 CANADA LTD.


6734 75 ST NW # 2 EDMONTON, AB, T6E 6T9 PHONE: (780) 450-4512 FAX: 1-888-872-6593 REVISED 2021-06-12


APNDX-7

PENETRATION DETAIL

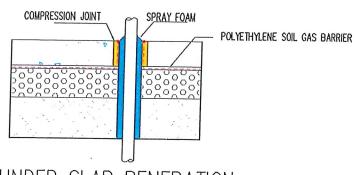

UNDER SLAB PENERATION

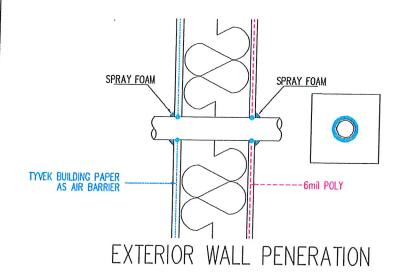


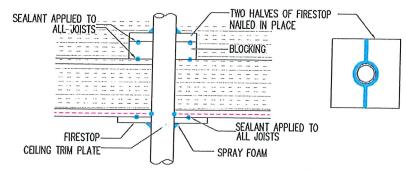


CEILING PENERATION


NOTE:


HEAT DUCT AND COLD AIR RETURNS ARE
TO BE PROTECTED WITH A THERMAL BARRIER
MINIMUM 1/2 INCH GYPSUM BOARD, METAL
IS NOT A RESIDENTIAL TEHERMAL BARRIER.

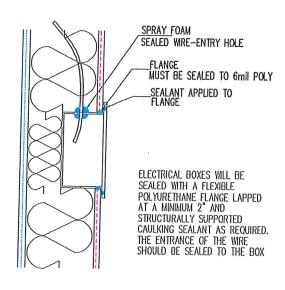

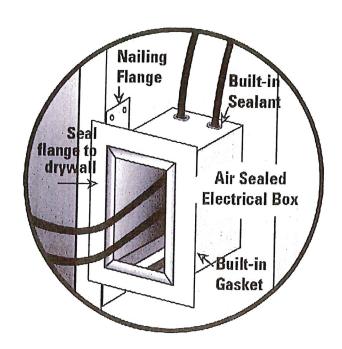

ELECTRICAL BOXES

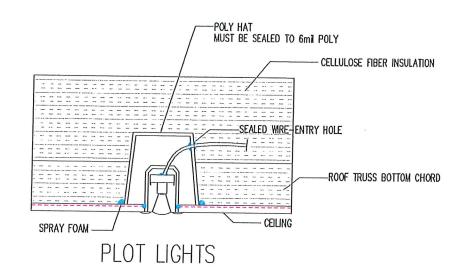

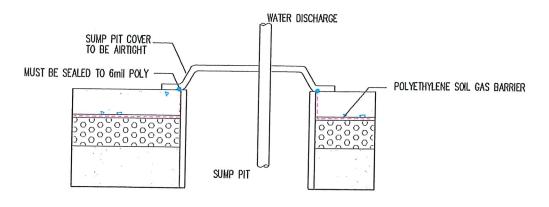


SUMP PIT INSTALLATION

HI—TECH DESIGNS 6734 75 ST NW # 2 CANADA LTD.

6734 75 ST NW # 2 CANADA LTD. EDMONTON, AB, T6E 6T9
PHONE: (780) 450-4512
FAX: 1-888-872-6593

2021-06-12 APNDX-6

REVISED

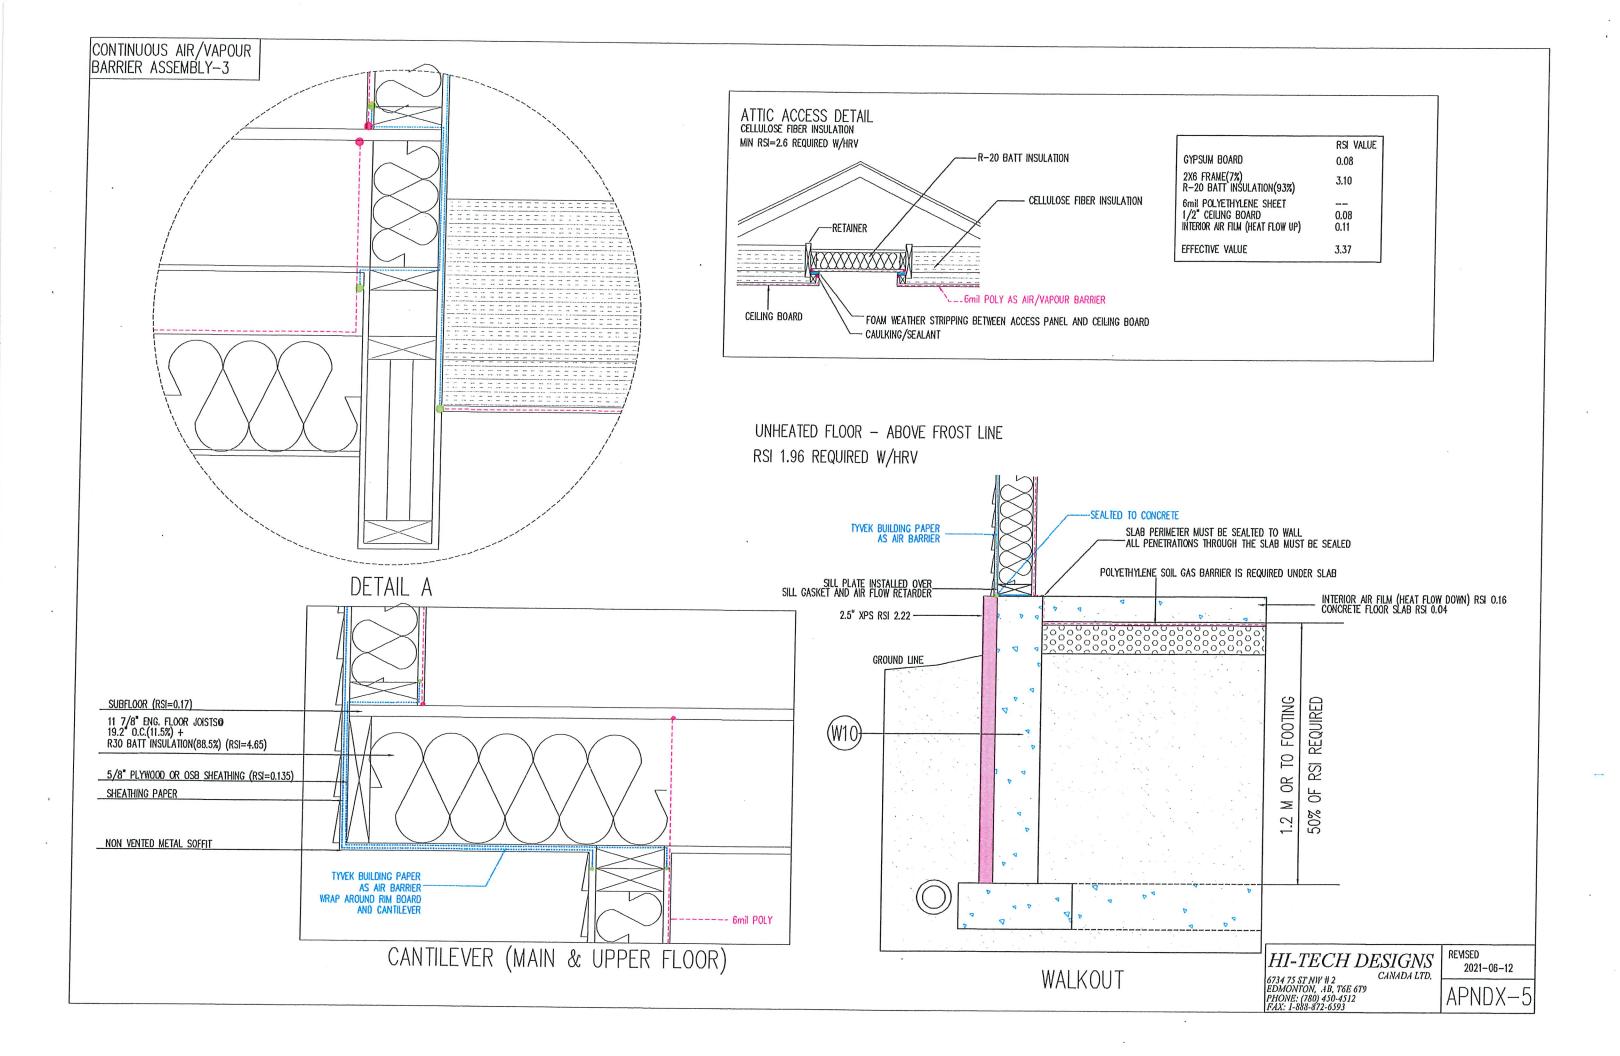

MUNICIPAL PLANNING COMMISSION (MPC) REQUEST FOR DECISION

Proposed Development: Install Roof Top Solar System

Subject Site:

Lot 29, Block 25, Plan 782 1890 – 4823 44 Avenue, Gibbons, AB

Zoning:

R-1 Single Family Residential

Permit Number:

25-D0039

Application Information

An application for the installation of a residential flush mount roof mounted solar panel system was received by the planning department and deemed complete on July 30, 2025. The proposed development is a discretionary use in the R-1 Single Family District and as such has come to the MPC for a decision.

Section 2.21 of the Land Use Bylaw 8-06 requires that the roof mounted solar panels be located in a manner such that light reflection does not negatively impact adjacent properties.

Recommendation

That the Municipal Planning Commission approve the application for the installation of a residential flush mount roof mounted solar panel system to be located at Lot 29, Block 25, Plan 782 1890 – 4823 44 Avenue, Gibbons, AB with the following conditions:

- 1. Development shall proceed in accordance with the attached plans.
- 2. The roof mounted solar panels shall be located in a manner such that light reflection does not negatively impact adjacent properties.
- 3. If the development authorized on this development permit is not commenced within twelve (12) months of the Date of Issuance, or the applicant has not obtained an approved Building Permit within twelve (12) months from the Date of Issuance, the Development Permit shall be deemed void.
- 4. The Applicant/Registered Owner shall ensure there is no damage to municipal property resulting from this permit. Costs for repairs of municipal property will be assessed by the Town of Gibbons and will be charged back to the applicant.

NOTES:

- If the development is found to be incorrectly placed, the applicant may be required to
 move or remove the development at the sole expense of the Applicant/Registered Owner.
 Any proposed change considered to be substantial or inconsistent with this approval, as
 determined by the Development Officer, may be subject to a separate development permit
 application/approval.
- 2. An appeal can be made by filing a written notice of appeal along with payment to the Subdivision and Development Appeal Board (4807 50 Avenue, Box 68, Gibbons, AB, T0A 1N0) within 21 days from the date of the receipt of this decision. In the case of an appeal made by a person referred to in section 685(2) of the Municipal Government Act, within 21 days after the date on which the notice of the issuance of the permit was given.

- 3. This is a Development Permit ONLY. Issuance of this Permit does not excuse the applicant from satisfying all other applicable municipal, provincial and/or federal requirements.
- 4. A person applying for, or in possession of a valid Development Permit is not relieved from full responsibility for ascertaining and complying with or carrying out development in accordance with the conditions of any covenant, caveat, easements, or other instrument effecting the building or the land.


Submitted By:

Terra Pattison, Acting Development Officer



NOTES:

- ALL ELECTRICAL BUILDING PENETRATIONS FOR SOLAR PV INSTALL TO BE PROPERLY SEALED TO MAINTAIN INTEGRITY OF THE EXISTING ENVELOPE
- (E) DENOTES EXISTING EQUIPMENT
- (N) DENOTES NEW EQUIPMENT
- (EXT) DENOTES EQUIPMENT LOCATED OUTSIDE
- (1F) DENOTES EQUIPMENT LOCATED INSIDE ON 1ST FLOOR
- (B) DENOTES EQUIPMENT LOCATED IN THE BASEMENT

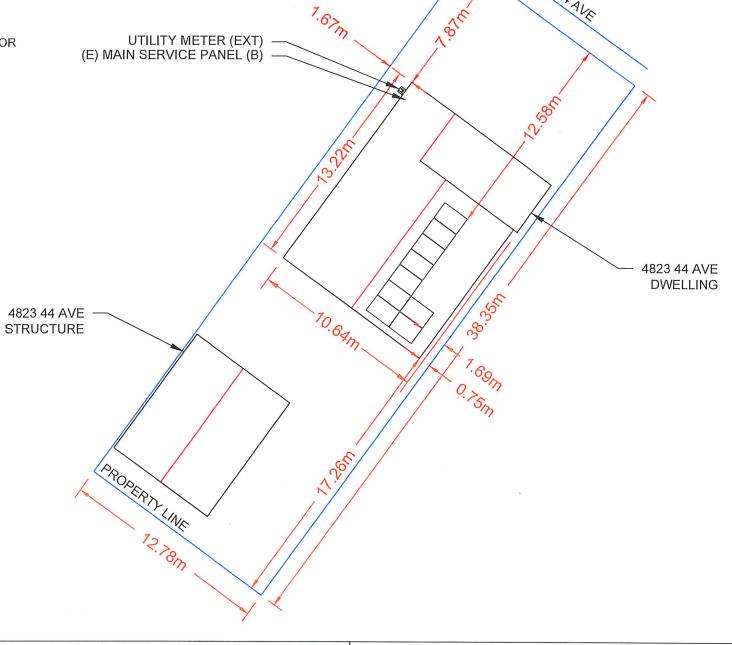

SCALE: 1:225

AHJ: TOWN OF GIBBONS, AB **GOVERNING CODE:**

FIREFLY

NATIONAL FIRE CODE – 2023 ALBERTA EDITION NATIONAL BUILDING CODE - ALBERTA 2023 2024 CANADIAN ELECTRICAL CODE

NOTES:

SCALE AS SHOWN

- ALL DIMENSIONS IN METERS UNLESS OTHERWISE STATED

NEAREST URGENT CARE FACILITY

NAME:

ADDRESS:

PHONE NUMBER:

FIREFLY SOLAR +1-888-912-9462 FIREFLYSOLAR.CA

PROJECT: 4823 44 AVE MUNICIPALITY: GIBBONS, AB POSTAL CODE: T0A 1N1 CLIENT: KENNETH A DAVIS 4.05 KW DC-STC / 3.240 KW AC

AUTHOR: ----

DATE: 10/JUL/25


REV: -


SITE PLAN


PERMIT TO PRACTICE EXACTUS ENERGY INC.


PERMIT NUMBER: P016590
The Association of Professional Engineers and Geosclentists of Alberta (APEGA)


RM APEGA ID #: 313353

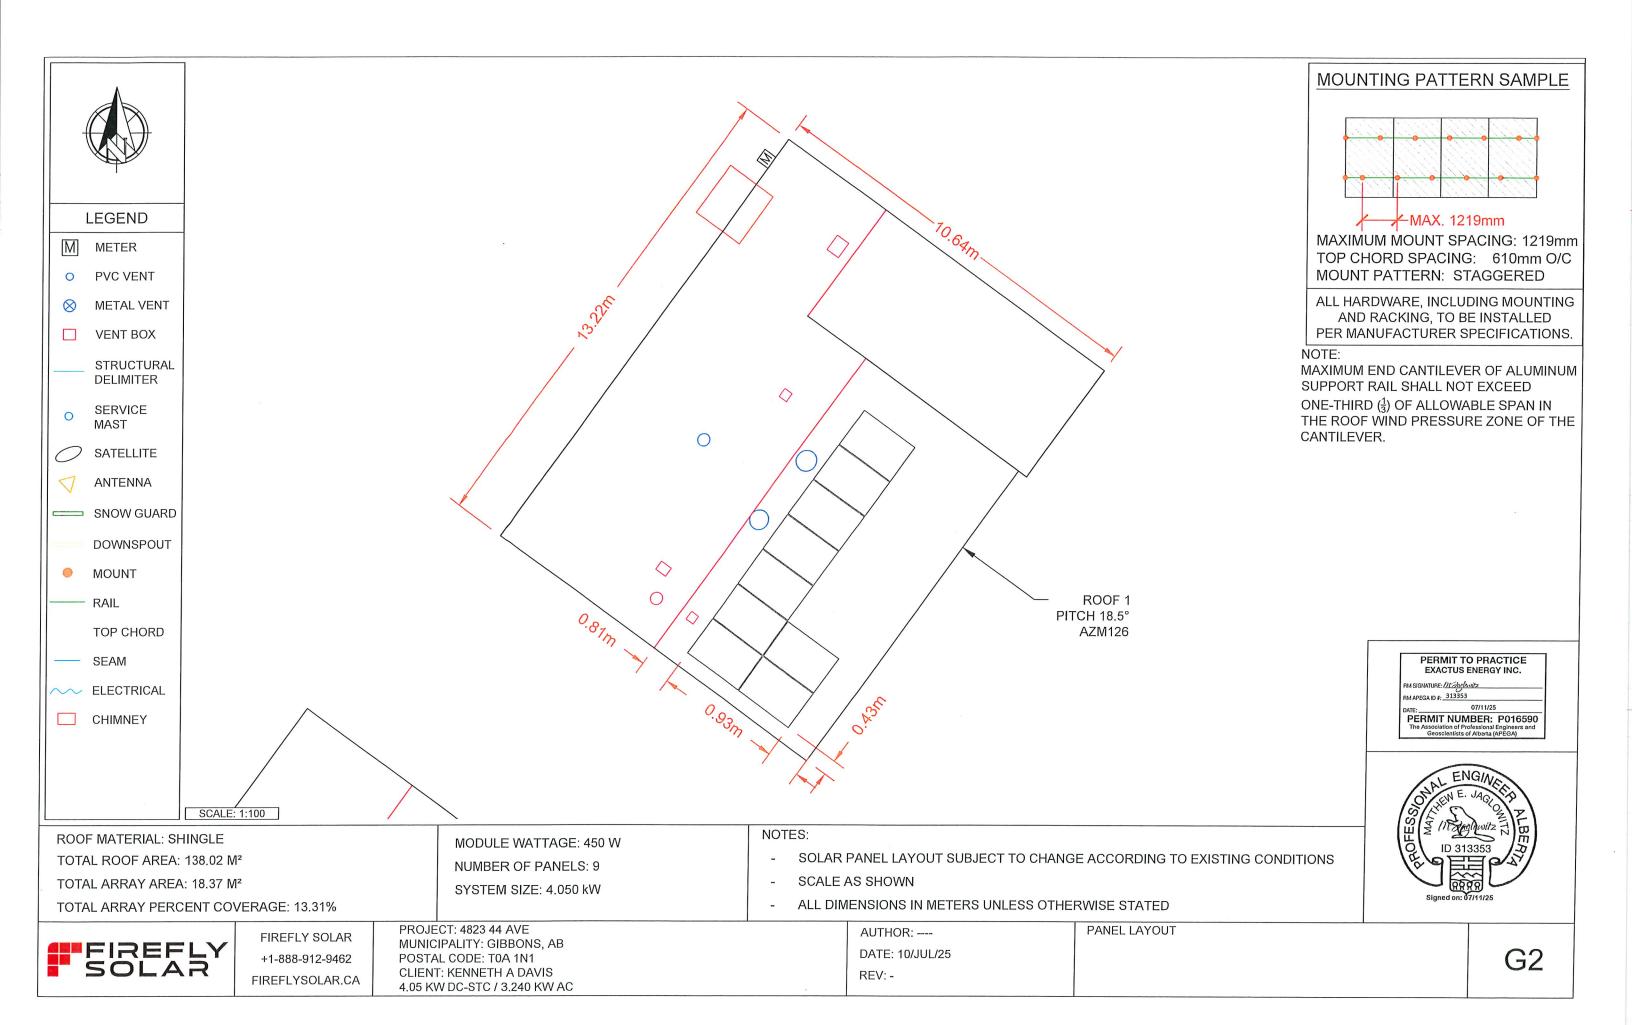

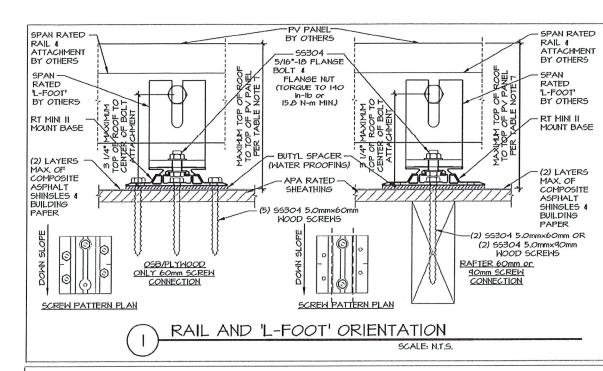

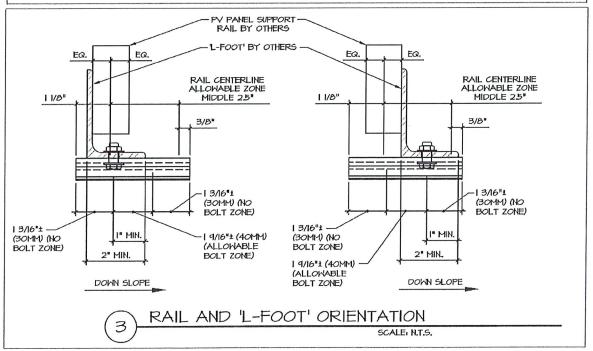

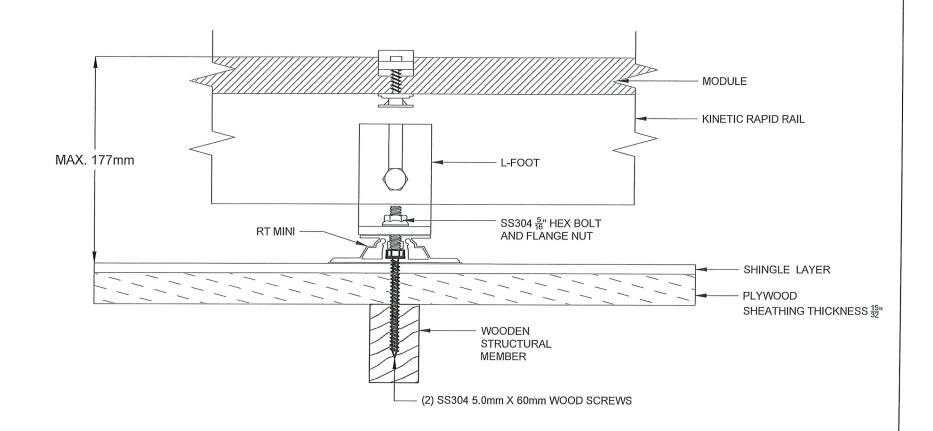

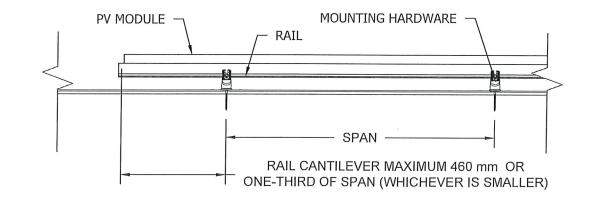


PERMIT TO PRACTICE EXACTUS ENERGY INC.

SIGNATURE: /11 Daglaw

RM APEGA ID #: 313353 DATE: 07

PERMIT NUMBER: P016590
The Association of Professional Engineers and
Geoscientists of Alberta (APEGA)

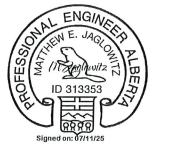

NOTES:

- SCALE AS SHOWN
- ALL DIMENSIONS IN METERS UNLESS OTHERWISE STATED

FIREFLY

MOUNT TYPE: RT MINI II

PANEL TYPE: LONGI LR7-54HGBB 450W

PANEL SIZE: 1800.00mm X 1134.00mm


RACKING TYPE: KINETIC RAPID RAIL


SOLAR SYSTEM DEAD LOAD: 0.17kN/m²

FIREFLY SOLAR +1-888-912-9462 FIREFLYSOLAR.CA PROJECT: 4823 44 AVE MUNICIPALITY: GIBBONS, AB POSTAL CODE: T0A 1N1 CLIENT: KENNETH A DAVIS 4.05 KW DC-STC / 3.240 KW AC

AUTHOR: ---DATE: 10/JUL/25
REV: -

ATTACHMENT DETAILS

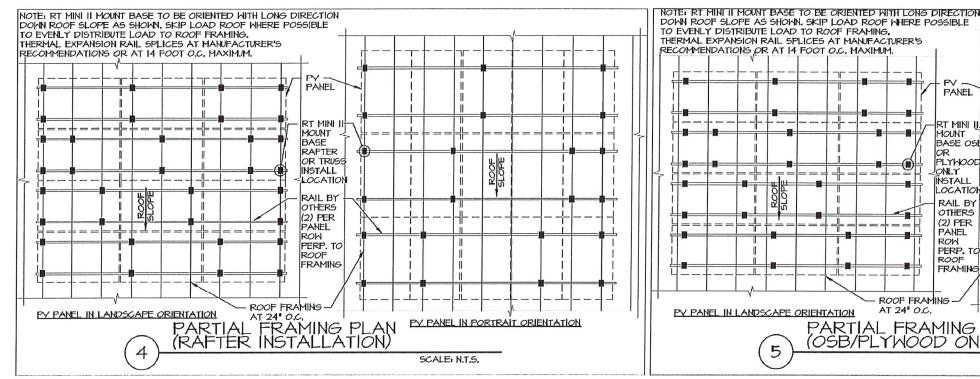

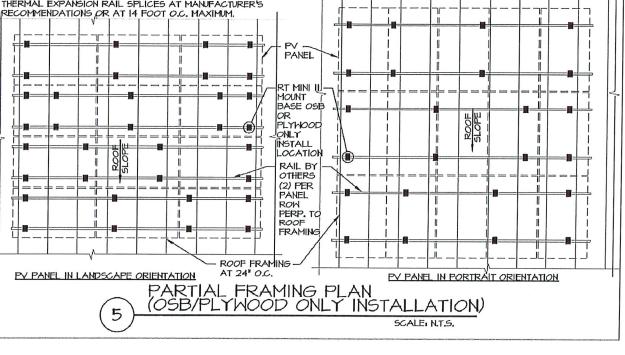

PANEL TYPE: LONGI LR7-54HGBB 450W

PANEL SIZE: 1800.00mm X 1134.00mm RACKING TYPE: KINETIC RAPID RAIL

MOUNT TYPE: RT MINI II

SOLAR SYSTEM DEAD LOAD: 0.17kN/m²

NOTES:

- SCALE AS SHOWN
- ALL DIMENSIONS IN METERS UNLESS
 OTHERWISE STATED

REV: -



PERMIT TO PRACTICE EXACTUS ENERGY INC.

PERMIT NUMBER: P016590

RM SIGNATURE: (11) an law vits RM APEGA ID #: 313353




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FIREFLYSOLAR.CA

PROJECT: 4823 44 AVE MUNICIPALITY: GIBBONS, AB POSTAL CODE: T0A 1N1 CLIENT: KENNETH A DAVIS 4.05 KW DC-STC / 3.240 KW AC

AUTHOR: ----DATE: 10/JUL/25 RACK CONNECTION DETAILS

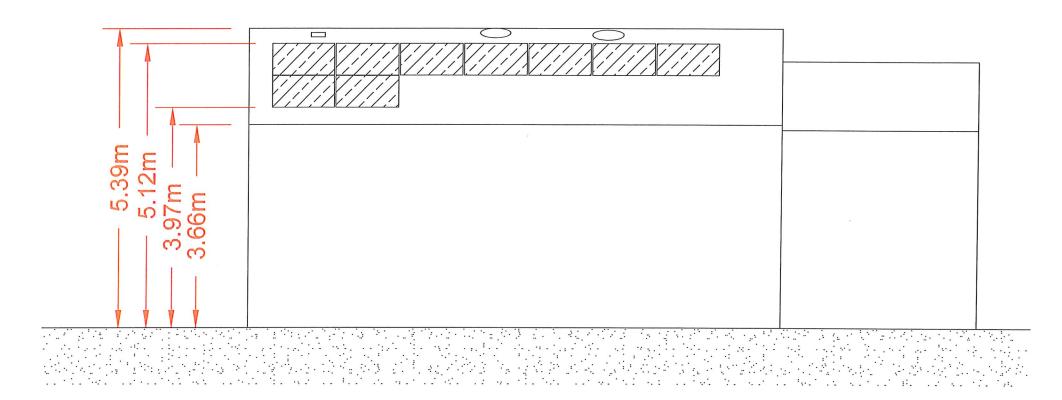

SOUTHEAST ELEVATION

SCALE: NTS

PANEL TYPE: LONGI LR7-54HGBB 450W PANEL SIZE: 1800.00mm X 1134.00mm RACKING TYPE: KINETIC RAPID RAIL

MOUNT TYPE: RT MINI II

SOLAR SYSTEM DEAD LOAD: 0.17kN/m²

NOTES:

- SCALE AS SHOWN
- ALL DIMENSIONS IN METERS UNLESS OTHERWISE STATED



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PERMIT NUMBER: P016590
The Association of Professional Engineers and
Geosclentists of Alberta (APEGA)

RM APEGA ID #: 313353

AUTHOR: ----

SIDE HOUSE ELEVATION

FIREFLY

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DATE: 10/JUL/25 REV: -






LR7-54HGBB 440~460M

22.5% MAX MODULE EFFICIENCY	0~3% POWER TOLERANCE	<1% FIRST YEAR POWER DEGRADATION	0.4% YEAR 2-30 POWER DEGRADATION	HALF-CELL Lower operating temperat
-----------------------------	----------------------	--	--	---------------------------------------

Additional Value 30-Year Power Warranty

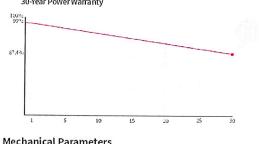

159 143 115

Cell Orientation	103 (6×18)
Junction Box	IP68
Dutput Cable	4mm², +400, -200mm/±1400mm length can be customized
Glass	Dual glass, 2.0+1.6mm semi tempered glass
rame	Anodized aluminum alloy frame
Veight	23.6/g
Dimension	1800×1134×30mm
Packaging	36pcs per pallet / 216pcs per 20' GP / 864pcs per 40' HC

								71.71		D-D
Electrical Characteristics	STC : AN	41.5 1000W/	m² 25°C	NOCT: AM	L.5 800V	V/m ² 20°C 1m/s	Test unc	ertainty for Pmax: =39	e	
Modul Type	LR7-54H	GBB-440M	LR7-54	HGBB-445M	LR7-5	54HGBB-450M	LR7-54H	IGBB-455M	LR7-54F	IGBB-460M
Testing Condition	STC	NOCT	STC	NOCT	ST	C NOCT	STC	NOCT	STC	NOCT
Max Power(Pmax/W)	440	334.9	445	333.8	45	0 3426	455	346	460	350
Open Grouit Voltage(Voc/V)	39.30	37.35	39.50	37.54	39.	70 37.73	39.90	37.92	40.10	38.11
Short Circuit Current (Isc/A)	14.23	11.43	14.30	1149	14.3	37 11.54	14.45	11.61	14.52	1166
Voltage at Maximum Power (Vmp/V)	32.82	31.19	33.02	3138	33.2	22 31.58	33.42	31.76	33.63	3L96
Current at Maximum Power (Imp/A)	13.41	31.19	13.48	1080	13.5	55 10 85	13.62	10.91	1368	1095
Module Efficiency (%)	2	1.6	21	8		22.0	7	2.3	2	25

Electrical characteristics	with different rear side p	ower gain (reference to 4	50W front)		
Pmax /W	Voc,V	Isc/A	Vmp/V	Imp/A	Pmax gain
473	39.70	15.09	33.22	14.22	5%
495	39,70	15.81	33.22	14.90	10%
518	39.80	16.53	33.32	15.58	15%
540	39.80	17.25	33.32	16.26	20%
563	39.80	17.96	33.32	16.93	25%

Operating Parameters Operational Temperature	-40°C ~ +85°C	
Maximum System Voltage	DC1500V (IEC/UL)	
Maximum Series Fuse Rating	30A	
Nominal Operating Cell Temperature	45±2°C	
Protection Class	Class II	
Bifaciality	80±10%	
Fire Rating	UL Type 38 IEC Class C	

Mechanical Loading			
Front Side Maximum Static Loading (e.g. snow	v, wind) 5400Pa		
Rear Side Maximum Static Loading (e.g. wind)	2400Pa		
Hailstone Test	25mm Hailstone at the speed of 23my		

Temperature Coefficient of Isc	+0.045%/°C
Temperature Coefficient of Voc	-0.230%/°C
Temperature Coefficient of Pmax	-0.230%/°C



No.8369 Shangyuan Road, Xi'an Economic And Technological Development Zone, Xi'an, Shaanxi, China. Web: www.longi.com

Specifications included in this datasheet are subject to change without notice. LONG reserves the right of final interpretation. (20240124Betal/01) DG



PERMIT TO PRACTICE EXACTUS ENERGY INC.

PERMIT NUMBER: P016590

RM SIGNATURE: ///)anlawitz
RM APEGA ID #: 313353



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PROJECT: 4823 44 AVE MUNICIPALITY: GIBBONS, AB POSTAL CODE: T0A 1N1 CLIENT: KENNETH A DAVIS 4.05 KW DC-STC / 3.240 KW AC


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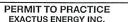
DATE: 10/JUL/25

REV: -

PANEL SPECIFICATIONS

A1



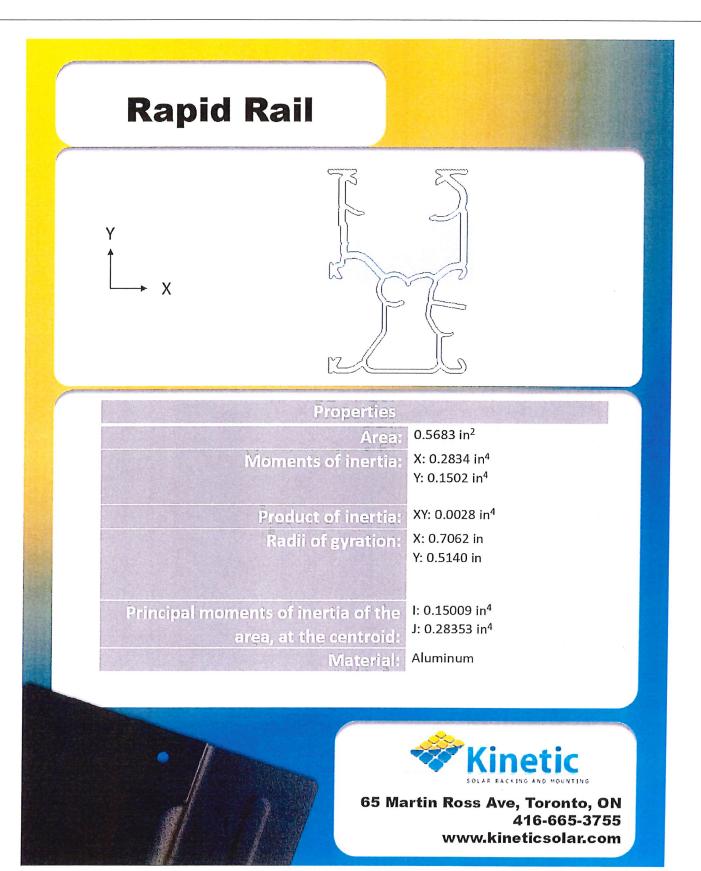

RM SIGNATURE: /// Onefervitz
RM APEGA ID #: 313353

DATE: 07/11/25
PERMIT NUMBER: P016590
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Geoscientists of Alberta (APEGA)





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PROJECT: 4823 44 AVE MUNICIPALITY: GIBBONS, AB POSTAL CODE: T0A 1N1 CLIENT: KENNETH A DAVIS 4.05 KW DC-STC / 3.240 KW AC

AUTHOR: ----DATE: 10/JUL/25

REV: -

RACKING SPECIFICATIONS

RT-MINI II

A Self-flashing PV Mount Featuring Roof Tech's AlphaSeal®



No Caulking or Pre-Drilling Required

Universal Attachment to Any Slope

Metal, EPDM, TPO, SBS, & Asphalt Roofs

Wide Range of Applications & Ultimate Flexibility on the Roof

No Need to Bend Rails N-S & Rotational Adjustments



Installation Manual




ICC ESR 3575




RT-MINI II is suitable for all systems with any L-Foot

Conduit Strap Installation

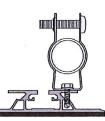

RT2-04-FBN25 **Hex Flange Bolt and Nut Set** Required for L-Foot Attachment

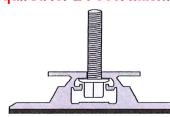

RT-MINI II

Flexible Flashing Certified by the International Code Council (ICC)

Components






MINI II base : 20 ea. Screw: 40 ea. Extra RT-Butyl: 4 ea.

Optional Items:

5 x 60mm Mounting Screw (RT2-04-SD5-60): 100 ea./Bag 5/16 X 25MM Flange Bolt & Nut (RT2-04-FBN25) : 100 ea./Bag RT-Butyl (RT2-04-MNBUTYL): 10 ea/Box

Deck Installation OSB & PLYWOOD ONLY



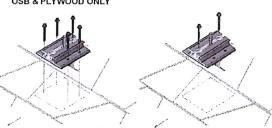

Roof Tech Inc. AlphaSeal™ Technology has been used on over one million residential PV systems since 1994. It is the first PV mounting system with Flexible Flashing certified by the ICC, engineered to withstand wind speeds up to 180 mph and ground snow up to 90 psf.

Engineered to ASTM D 1761 (Standard Test Methods for Mechanical Fasteners in Wood)

ICC ESR-3575 ASTM2140 Testing









Metal Flashing Retrofit




Dimensions in (mm)

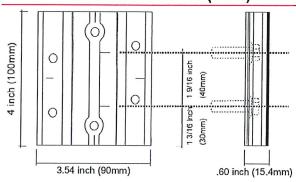




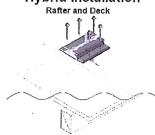

Offset Rafter Attachment Options

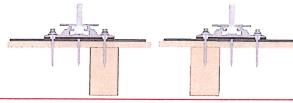

Flexible Flashing

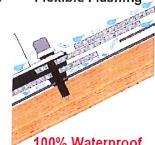

100% Waterproof



www.roof-tech.us info@roof-tech.us



Roof Tech Inc. www.roof-tech.us 10620 Treena Street, Suite 230, San Diego, CA 92131 858.935.6064

May 2023



PERMIT TO PRACTICE

EXACTUS ENERGY INC.





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PROJECT: 4823 44 AVE MUNICIPALITY: GIBBONS, AB POSTAL CODE: T0A 1N1 CLIENT: KENNETH A DAVIS 4.05 KW DC-STC / 3.240 KW AC AUTHOR: ----

DATE: 10/JUL/25

REV: -

MOUNTING SPECIFICATIONS



Microinverter Datasheet

HMS-1600-4T-NA HMS-1800-4T-NA HMS-2000-4T-NA

Description

Hoymiles new microinverter HMS-2000 series are suitable for high-powered solar panels, which rank among the highest for 4-in-1 microinverters.

Each microinverter can connect up to 4 panels, with independent MPPT and module-level monitoring maximizing the power production of your installation. With a maximum DC voltage of 65 volts, Hoymiles microinverter is a PV Rapid Shutdown Equipment and conforms with NEC-2017 and NEC-2020 Article 690.12 and CEC-2021 Sec 64-218.

The new Sub-1G wireless solution enables more stable communication with Hoymiles gateway DTU.

Features

High-powered microinverter for 4-in-1 series with superior performance

Safer for rooftop solar stations with PV rapid shutdown compliance

With Reactive Power Control, compliant with UL 1741, IEEE 1547, UL 1741 SB, etc.

Independent MPPT and monitoring ensure greater energy harvest and easier maintenance

4-in-1 design enables most cost-effective solar solution

Sub-1G wireless solution allows stable communication in commercial and industrial settings

Technical Specifications

Model	HMS-1	600-4T-NA	HMS-1800-4T-NA		HMS-2000-4T-NA	
Input Data(DC)						
Commonly used module power (W)	320 to 540+		360 to	360 to 600+		0 670+
Maximum input voltage (V)	Project Control			65		
MPPT voltage range (V)			16-60			
Start-up voltage (V)			22			
Maximum input current (A)	4× 12.5		4 × 13.3		4×14	
Maximum input short circuit current (A)			4×20			
Number of MPPTs			4			
Number of inputs per MPPT			1			
Output Data(AC)						
Peak output power (VA)	1600		1800		2000	
Maximum continuous output power (VA)	num continuous output power (VA) 1440		1660		1918	
Maximum continuous output current (A)	6.00	6 92	6.92	7.98	7.99	9.22
Nominal output voltage/range (V)	240/211-264	208/183-228	240/211-264	208/183-228	240/211-264	208/183-22
Nominal frequency/range (Hz)*			60/55	-65		
Adjustable power factor (@nominal power)			> 0.99 d 0.8 leading			
Total harmonic distortion (@nominal power)			< 3%			
Maximum units per 10 AWG branch [™]	4	3	3	3	3	2
Efficiency						
CEC peak efficiency	96.	70%	96.50%		96.50%	
Nominal MPPT efficiency			99.8%			
Night power consumption (mW)			< 50			
Mechanical Data						
Ambient temperature range (°F)			-40 to +149 (-40	0 to +65°C)		
Dimensions (W × H × D [ınch])		13	03 × 8.58 × 1.44 (331	1 × 218 × 36.6 m	m)	
Weight (lbs)			10.36 (4.7	7 kg)		
Endosure rating			Outdoor-NEM	A 6 (IP67)		
Cooling			Natural convecti	ion-No fans		

Communication

Galvanically Isolated HF Transformer

Type of isolation Monitoring

Compliance

S-Miles Cloud (Hoymiles Monitoring Platform)

Sub-1G

UL 1741, IEEE 1547, UL 1741 SB, CA Rule 21''', CSA C22.2 No 107 1-16, FCC 15B, FCC 15C

PV Rapid Shutdown


Conforms with NEC-2017 and NEC-2020 Article 690.12 and CEC-2021 Sec 64-218 Rapid Shutdown of PV Systems.

- * Nominal voltage/frequency range can vary depending on local requirements.

 ** Refer to local requirements for exact number of microinverters per branch

 ** The HMS-2000-4T-NA microinverter complies with both CA Rule 21 (240 Vac) and CA Rule 21 (208 Vac).

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RM APEGA ID #: 313353

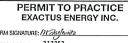PERMIT NUMBER: P016590





FIREFLY SOLAR +1-888-912-9462 FIREFLYSOLAR.CA

PROJECT: 4823 44 AVE MUNICIPALITY: GIBBONS, AB POSTAL CODE: T0A 1N1 CLIENT: KENNETH A DAVIS 4.05 KW DC-STC / 3.240 KW AC

AUTHOR: ----DATE: 10/JUL/25


REV: -

INVERTER SPECIFICATIONS 1

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hòymiles

Open Energy For All

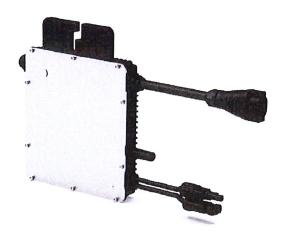

Microinverter **Datasheet**

HMS-350-1T-NA HMS-400-1T-NA HMS-450-1T-NA HMS-500-1T-NA

Description

Hoymles new microinverter HMS-500 series are suitable for highpowered solar panels, which rank among the highest for 1-in-1 microinverters.

Each microinverter can be connected to one panel and used in various applications, making it one of the most flexible solar solutions. With a maximum DC voltage of 65 volts, Hoymiles microinverter is a PV Rapid Shutdown Equipment and conforms with NEC-2017 and NEC-2020 Article 690.12 and CEC-2021 Sec 64-218.

The new Sub-1G wireless solution enables more stable communication with Hoymiles gateway DTU.

Features

High-powered microinverter for 1-in-1 series with superior performance



Safer for rooftop solar stations with PV rapid shutdown compliance



With Reactive Power Control, compliant with UL 1741, IEEE 1547, UL 1741 SB, etc.



1-in-1 design enables most flexible applications

Technical Specifications

Model	HMS-3	50-1T-NA	HMS-4	00-1T-NA	HMS-4	50-1T-NA	HMS-5	00-1T-NA	
Input Data(DC)					711113-4	30-11-117	111112-2		
Commonly used module power (W) 260 to 470+				to 540+	360	to 600+	400 to 670t		
Maximum input voltage (V)	60		65		65		400 to 670+ 65		
MPPT voltage range (V)				16				03	
Start-up voltage (V)			SET OF		,				
Maximum input current (A)	1	1.5	12.5		13.3		14		
Maximum input short circuit current (A)		16		20		20		20	
Number of MPPTs					20		20		
Number of inputs per MPPT					ı				
Output Data(AC)									
Peak output power (VA)	3	50	400		4	50	500		
Maximum continuous output power (VA)	3	319		60	4	10	475		
Maximum continuous output current (A)	1,33	1.53	1.50	1.73	1.71	1.98	1.98	2.28	
Nominal output voltage/range (V)	240/211-264	208/183-228	240/211-264	208/183-228	240/211-264	208/183-228	240/211-264	208/183-228	
Nominal frequency/range (Hz)*				60/5	5-65				
Adjustable power factor (@nominal power)			> 0.99 default 0.8 leading . 0.8 lagging						
Total harmonic distortion (@nominal power)				< 3					
Maximum units per 10 AWG branch"	18	15	16	13	14	12	12	10	
Maximum units per 12 AWG branch ™	12	10	10	9	9	8	8	7	
Efficiency									
CEC peak efficiency	96.70%		96.70%		96 50%		96.5	50%	
Nominal MPPT efficiency				99.80	0%				
Night power consumption (mW)				< 5	0				
Mechanical Data		•							
Ambient temperature range (°F)		6	-40 to +149 (-40°C to +65°C)						
Dimensions (W \times H \times D (inches))			7.17 × 6.46 × 1.18 (182 × 164 × 30 mm)						
Weight (lbs)			3 86 (1 75 kg)						
Enclosure rating			Outdoor-IP67 (NEMA 6)						
Cooling			Natural convection (no fans)						
Features									
Communication				Sub-1	G				
Type of isolation			Galvanically Isolated HF Transformer						
Monitoring			S-Miles Cloud (Hoymiles Monitoring Platform)						
Compliance				UL 1741, IEEE 1547, UL 1741 SB, CA Rule 21, CSA C22.2 No. 107.1-16, FCC 15B, FCC 15C					
PV Rapid Shutdown Conforms with NEC-2017 and NEC-2020 Article 690.12 and CEC-2021 Sec 64-218 Rapid Shutdown of PV Systems									

* : Nominal voltage/frequency range can vary depending on local requirements

**. Refer to local requirements for exact number of microinverters per branch.

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PERMIT NUMBER: P016590

RM SIGNATURE: /// Dayla vitz RM APEGA ID #: 313353

AUTHOR: ----

DATE: 10/JUL/25

REV: -

INVERTER SPECIFICATIONS 2

FIREFLY

FIREFLY SOLAR +1-888-912-9462 FIREFLYSOLAR.CA PROJECT: 4823 44 AVE MUNICIPALITY: GIBBONS, AB POSTAL CODE: T0A 1N1 CLIENT: KENNETH A DAVIS 4.05 KW DC-STC / 3.240 KW AC

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